# Site Plan for

# Williamsburg Safety Complex Williamsburg, Massachusetts SITE PLAN REVIEW SUBMISSION

# Prepared For:

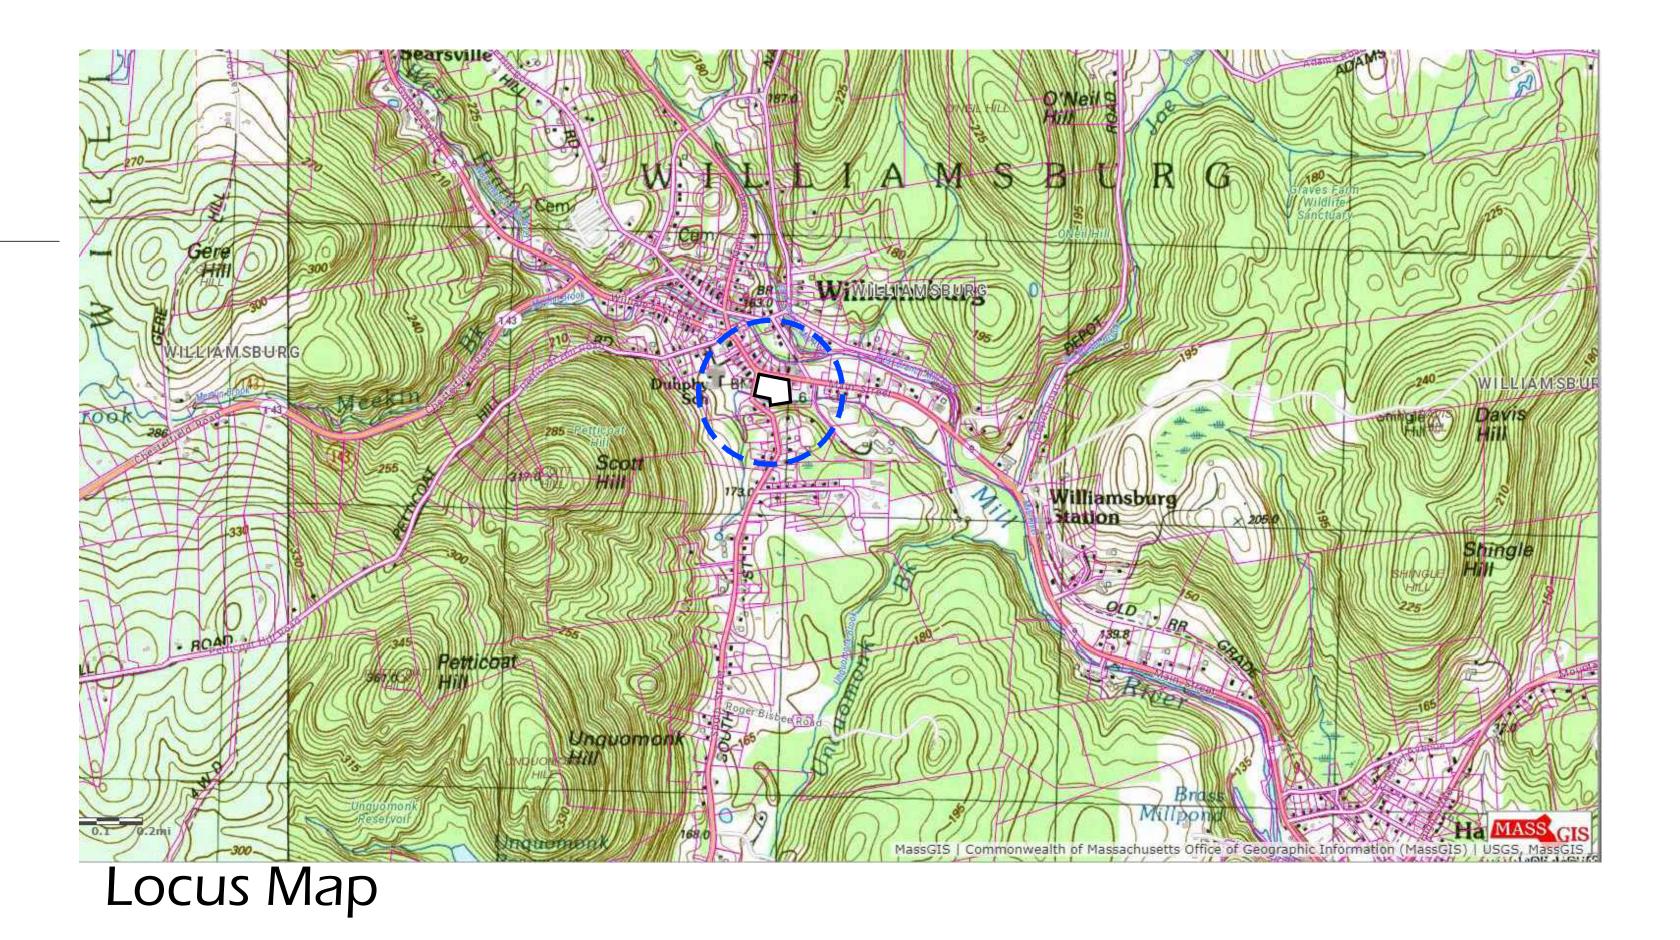
Town of Williamsburg 141 Main St Haydenville, MA 01039

# Prepared By:



Landscape Architecture Civil Engineering Planning Land Surveying

4 Allen Place Northampton Massachusetts 01060 www.berkshiredesign.com



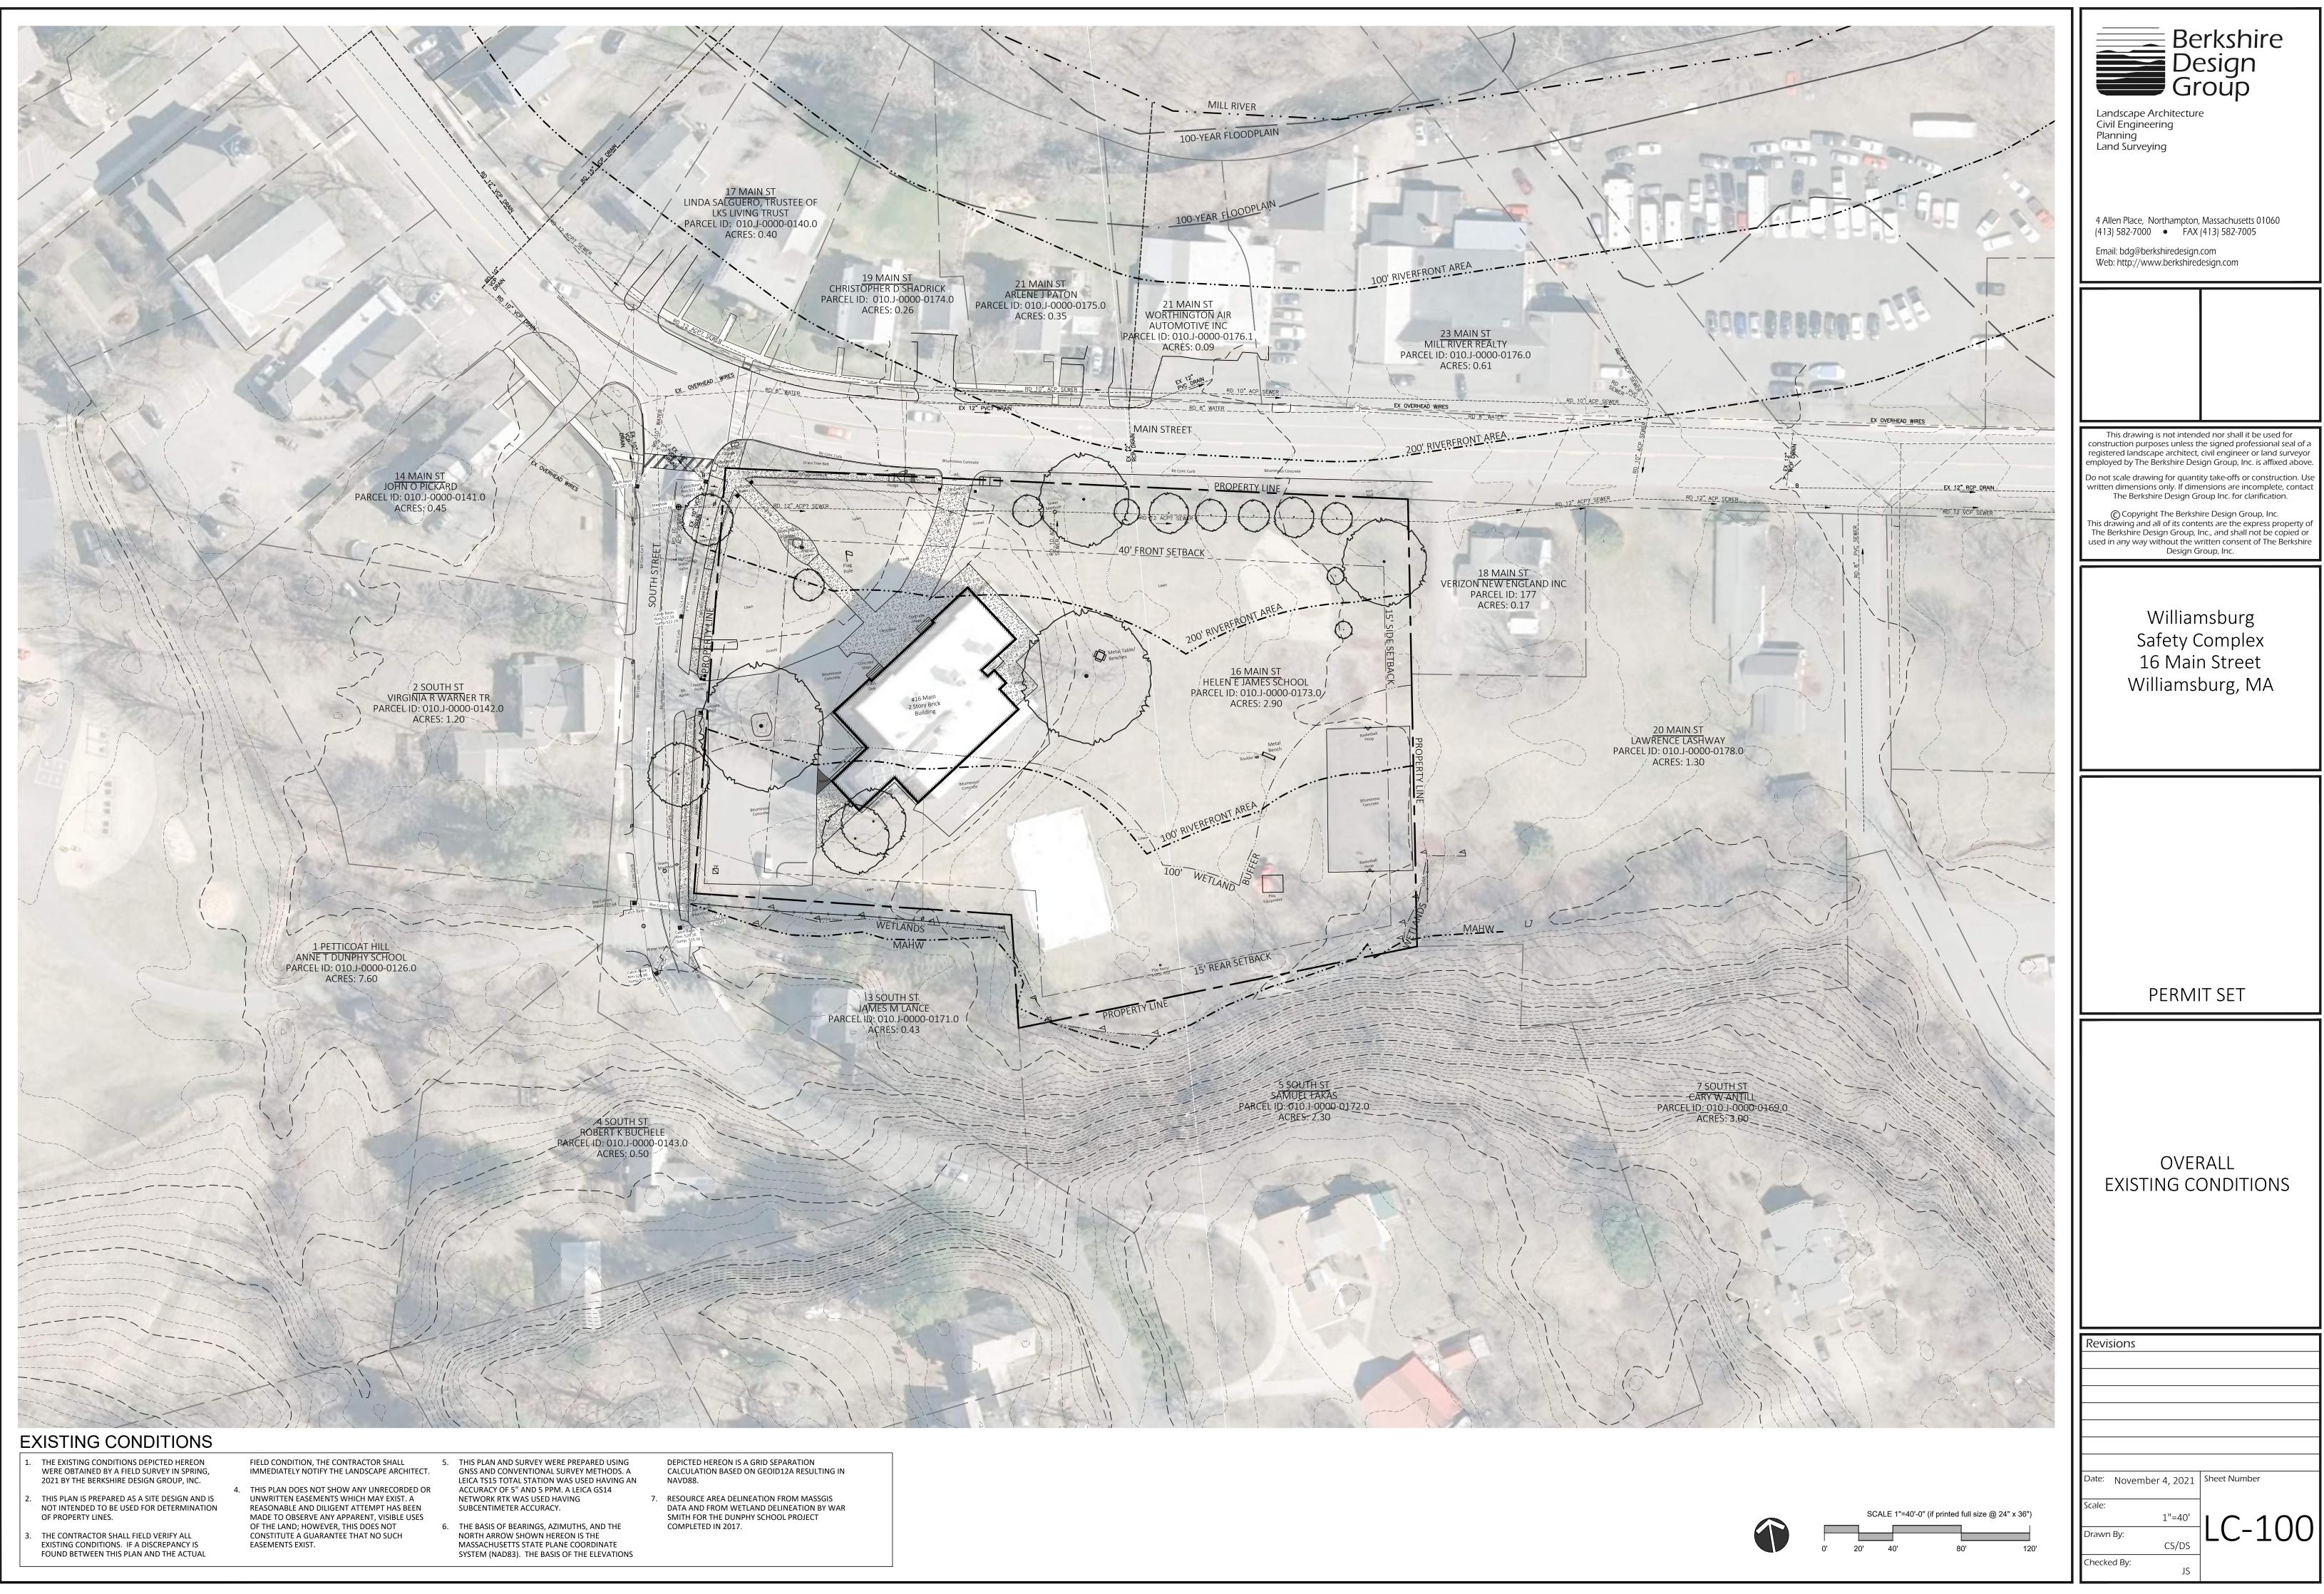
### Date:

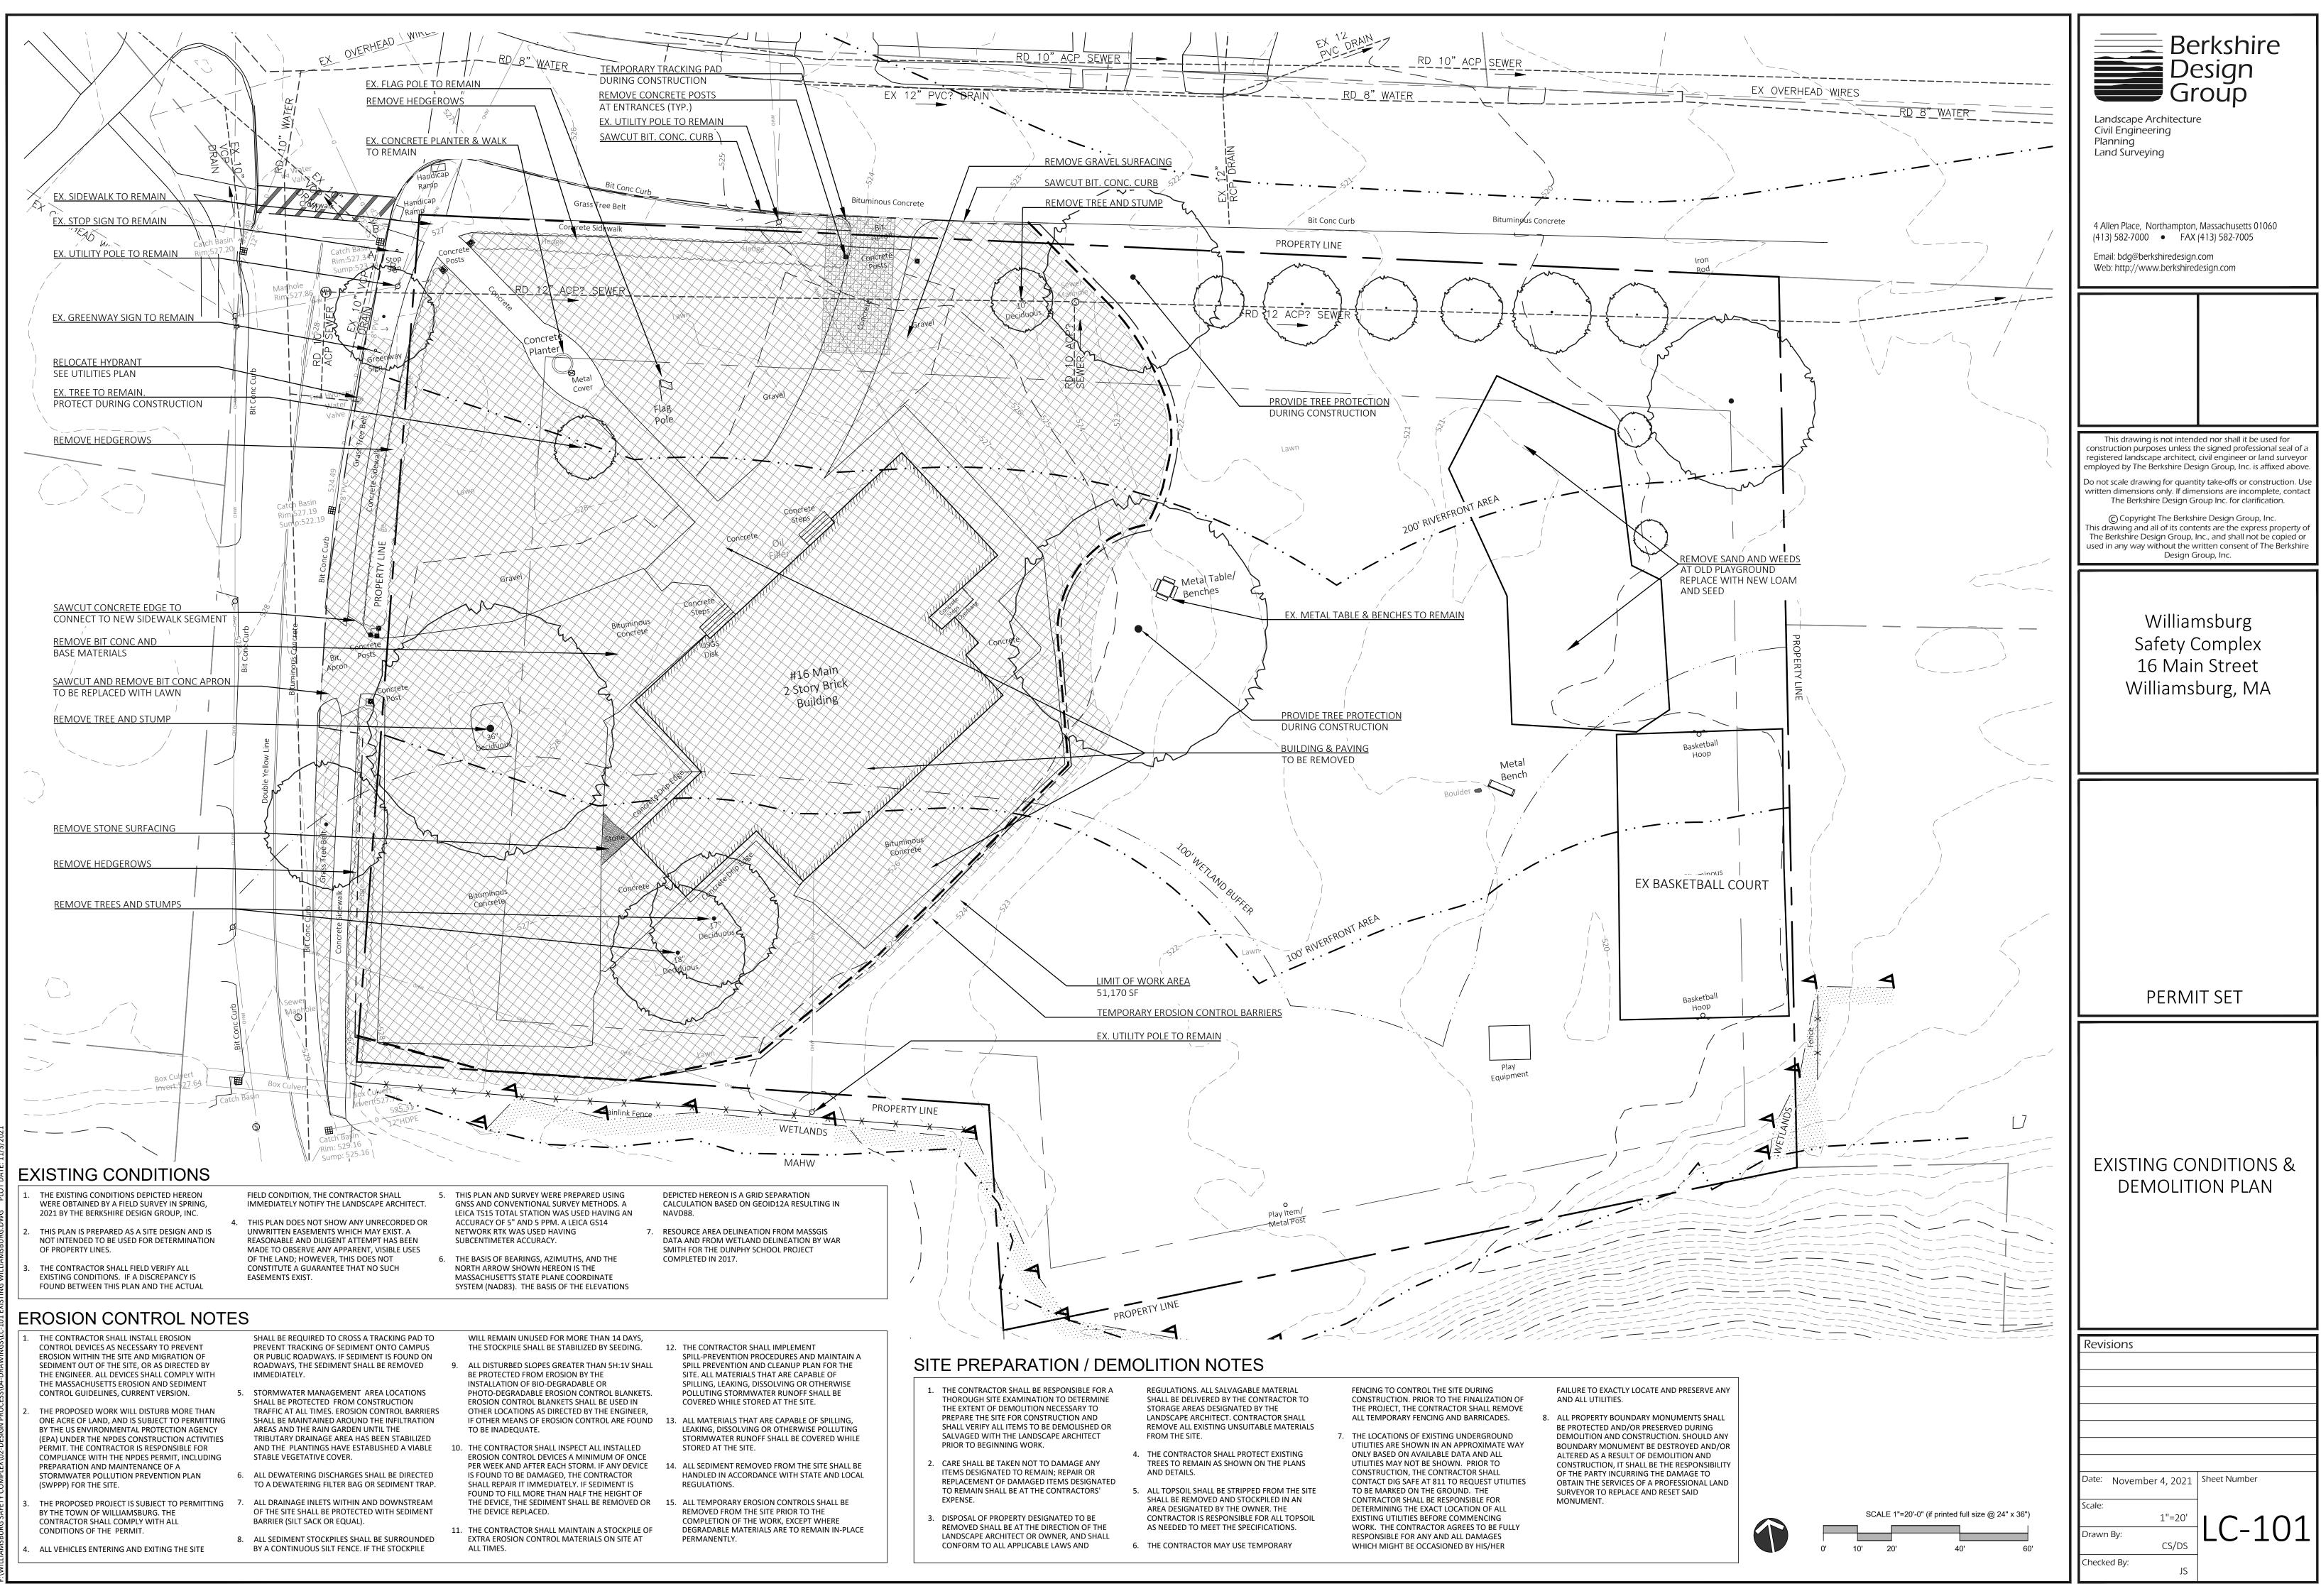
November 4, 2021

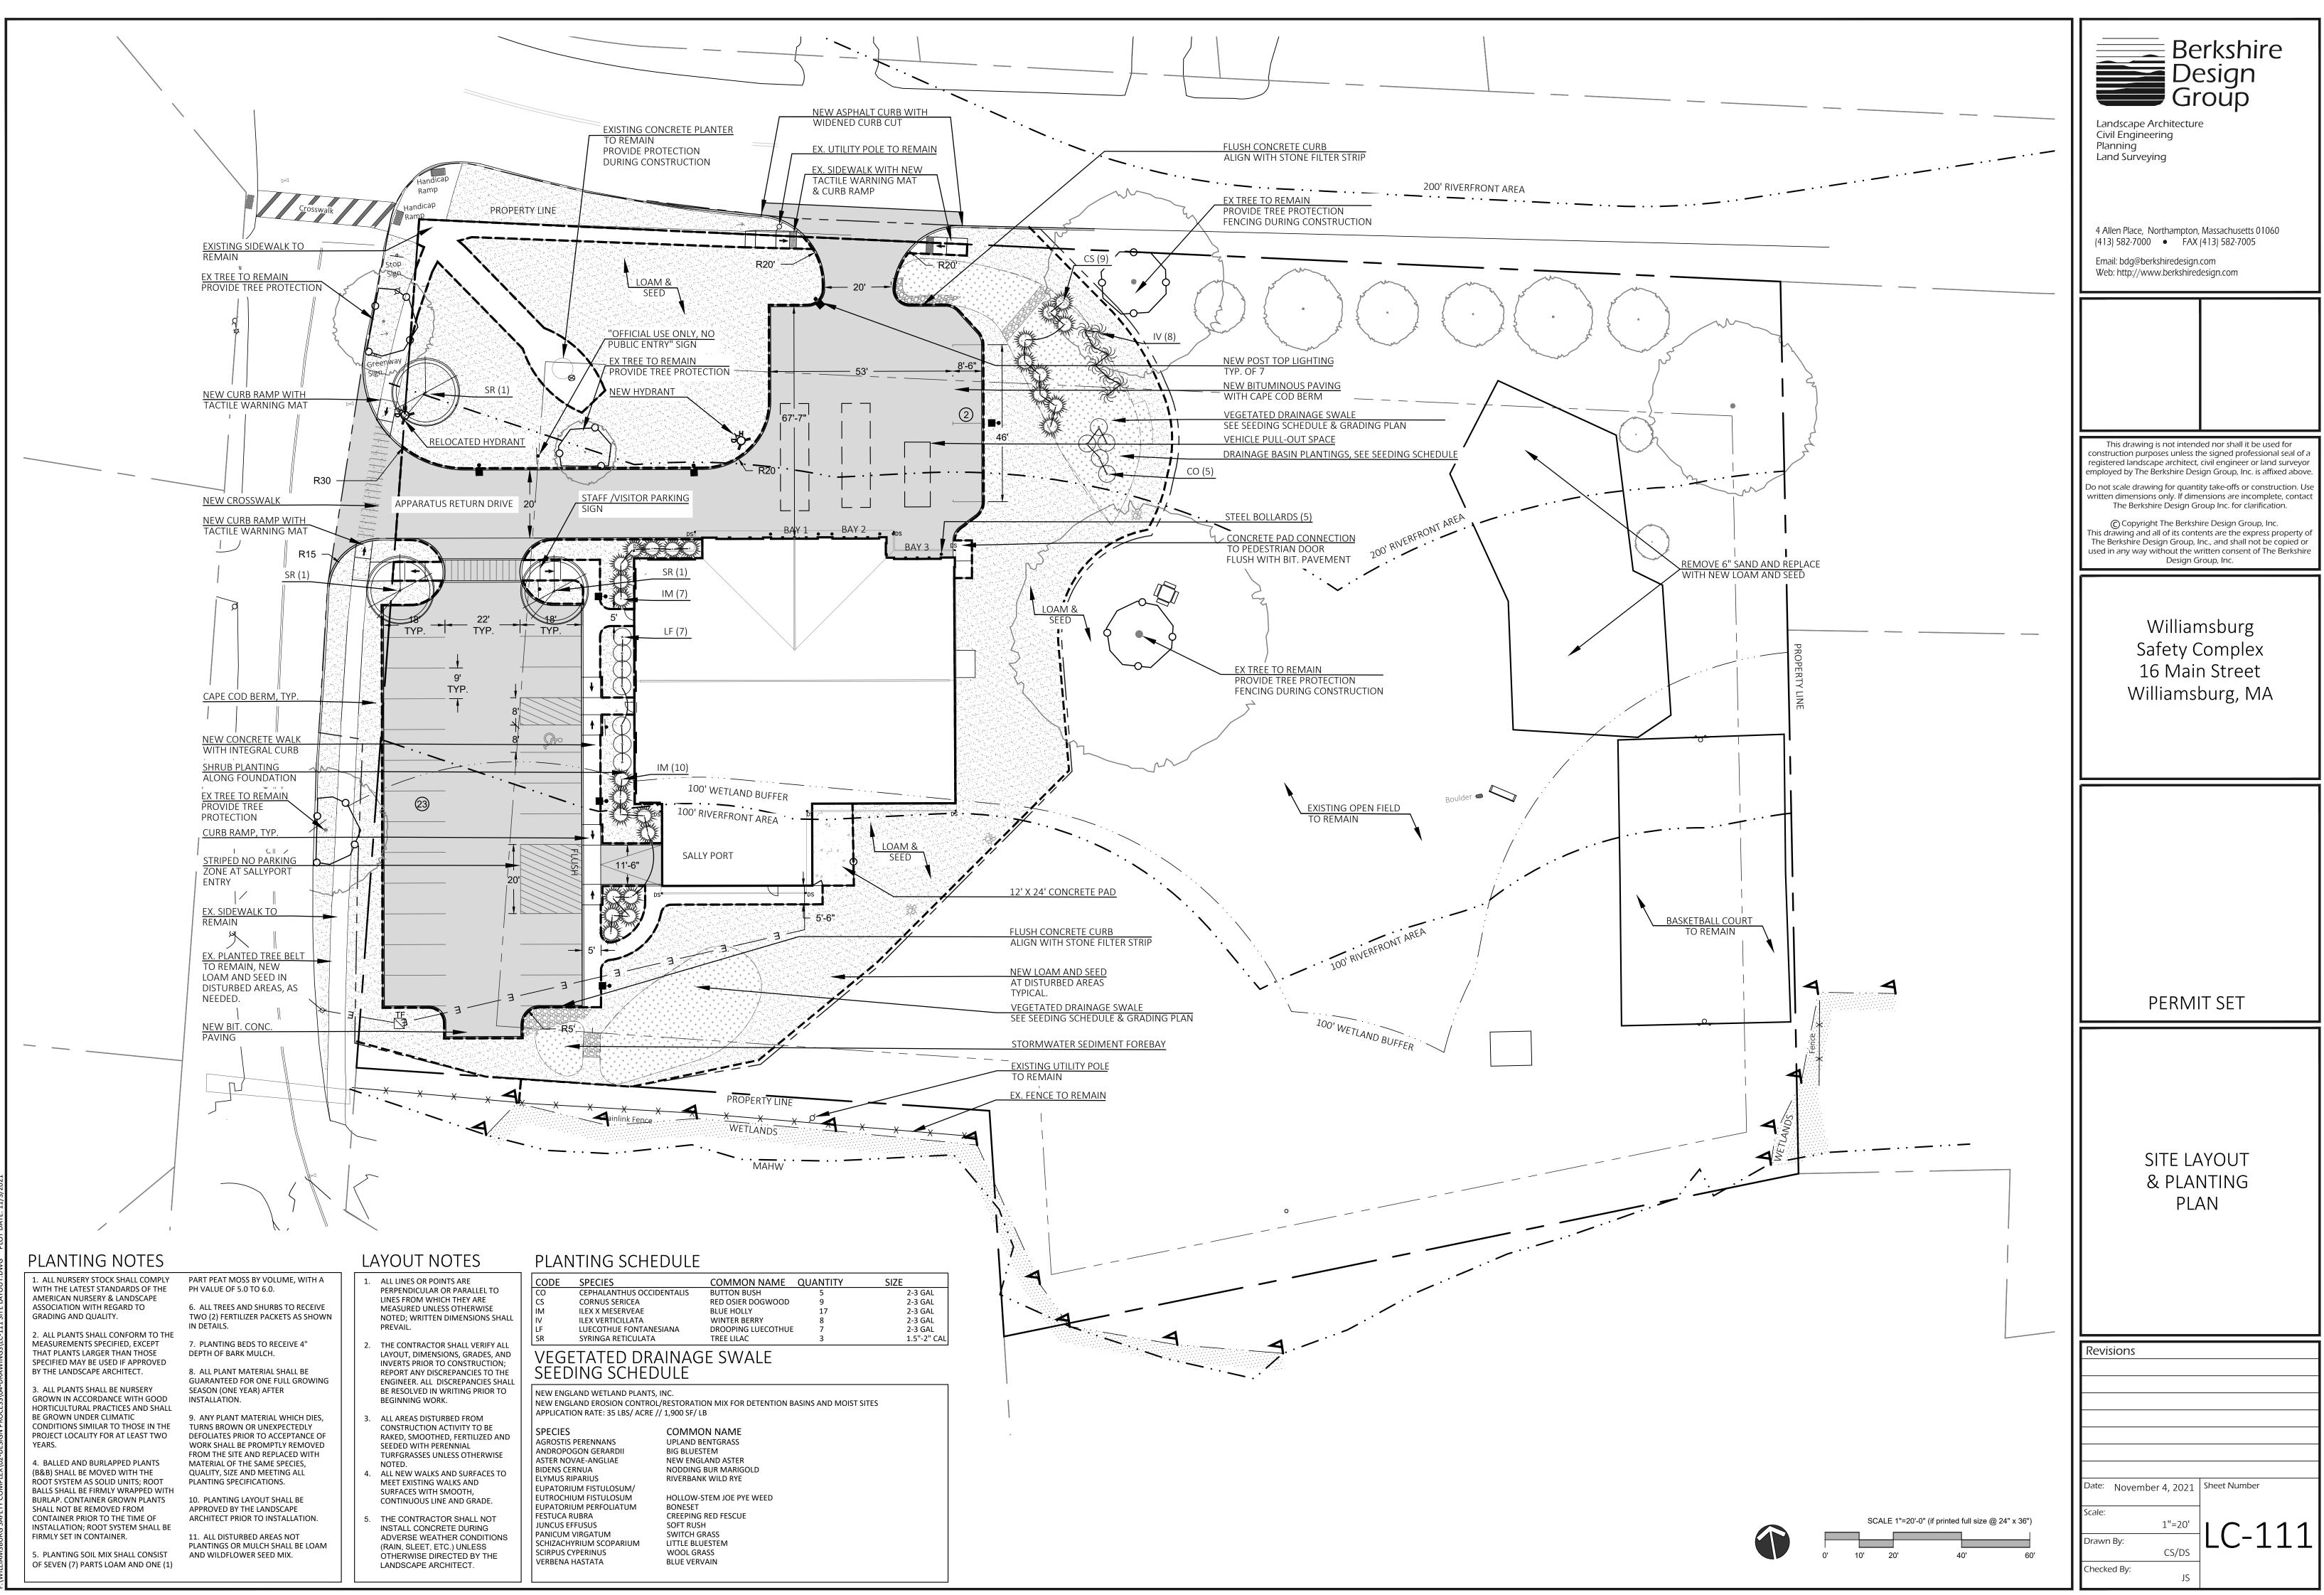
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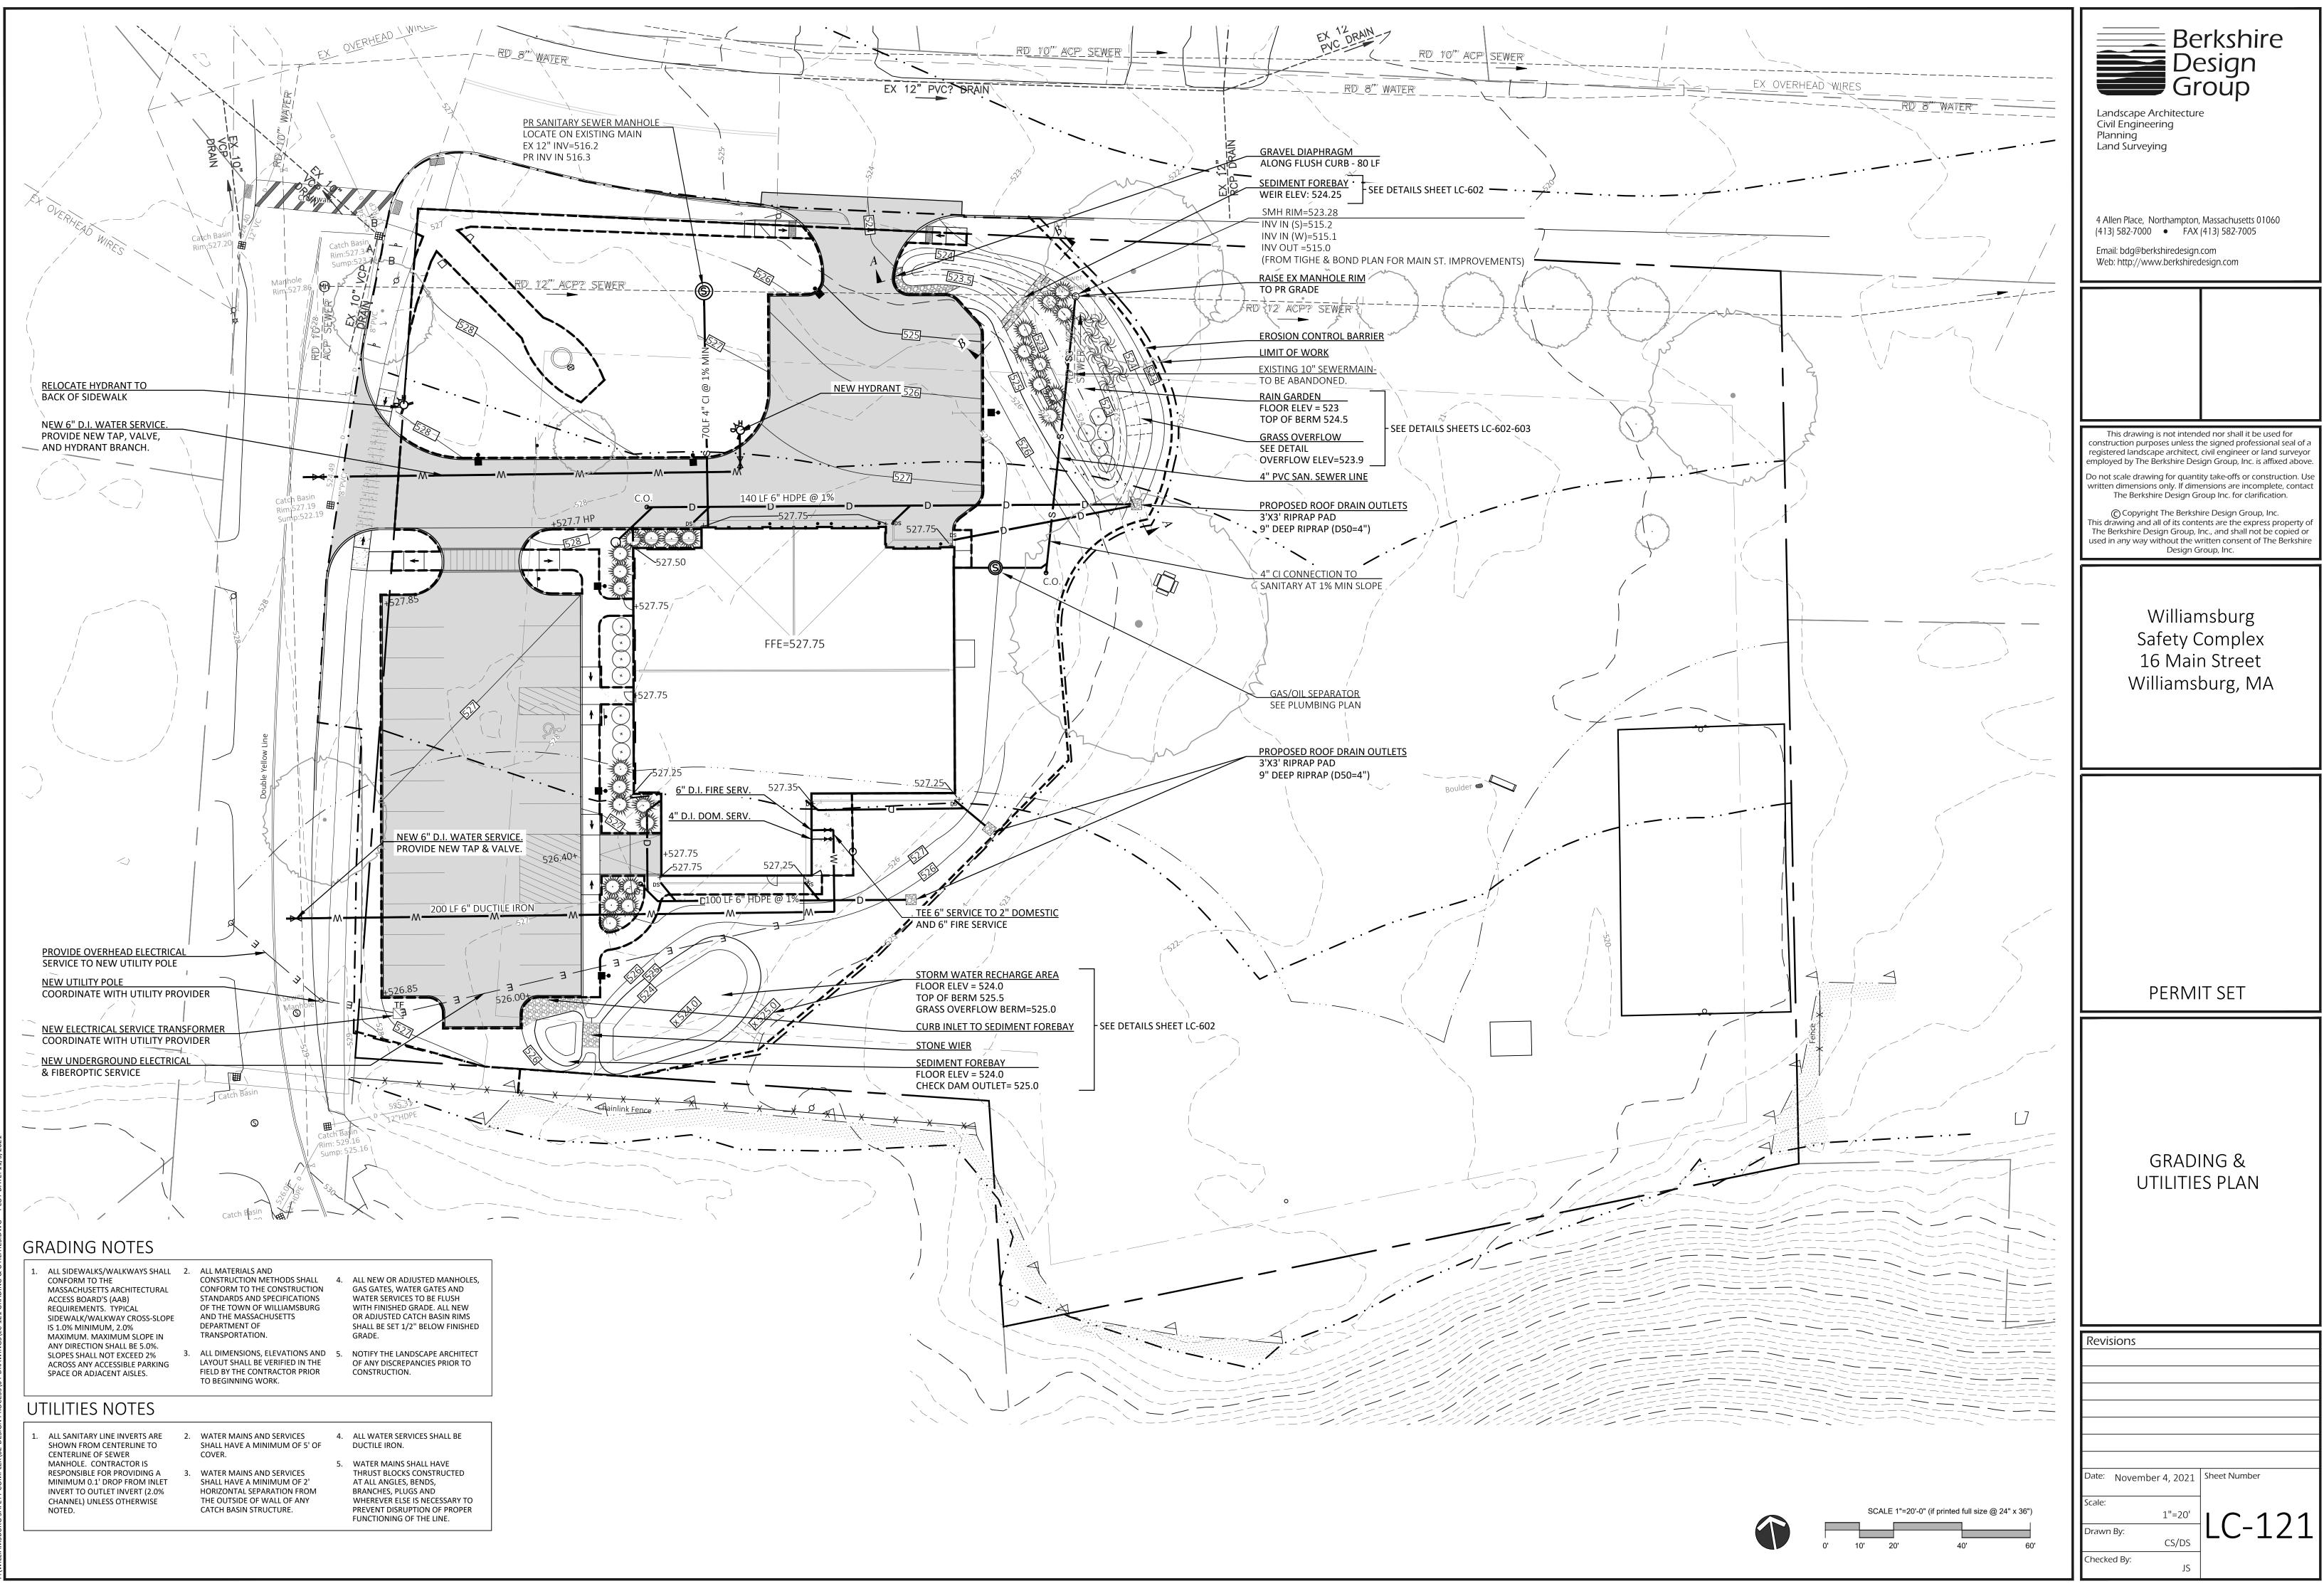
COVER

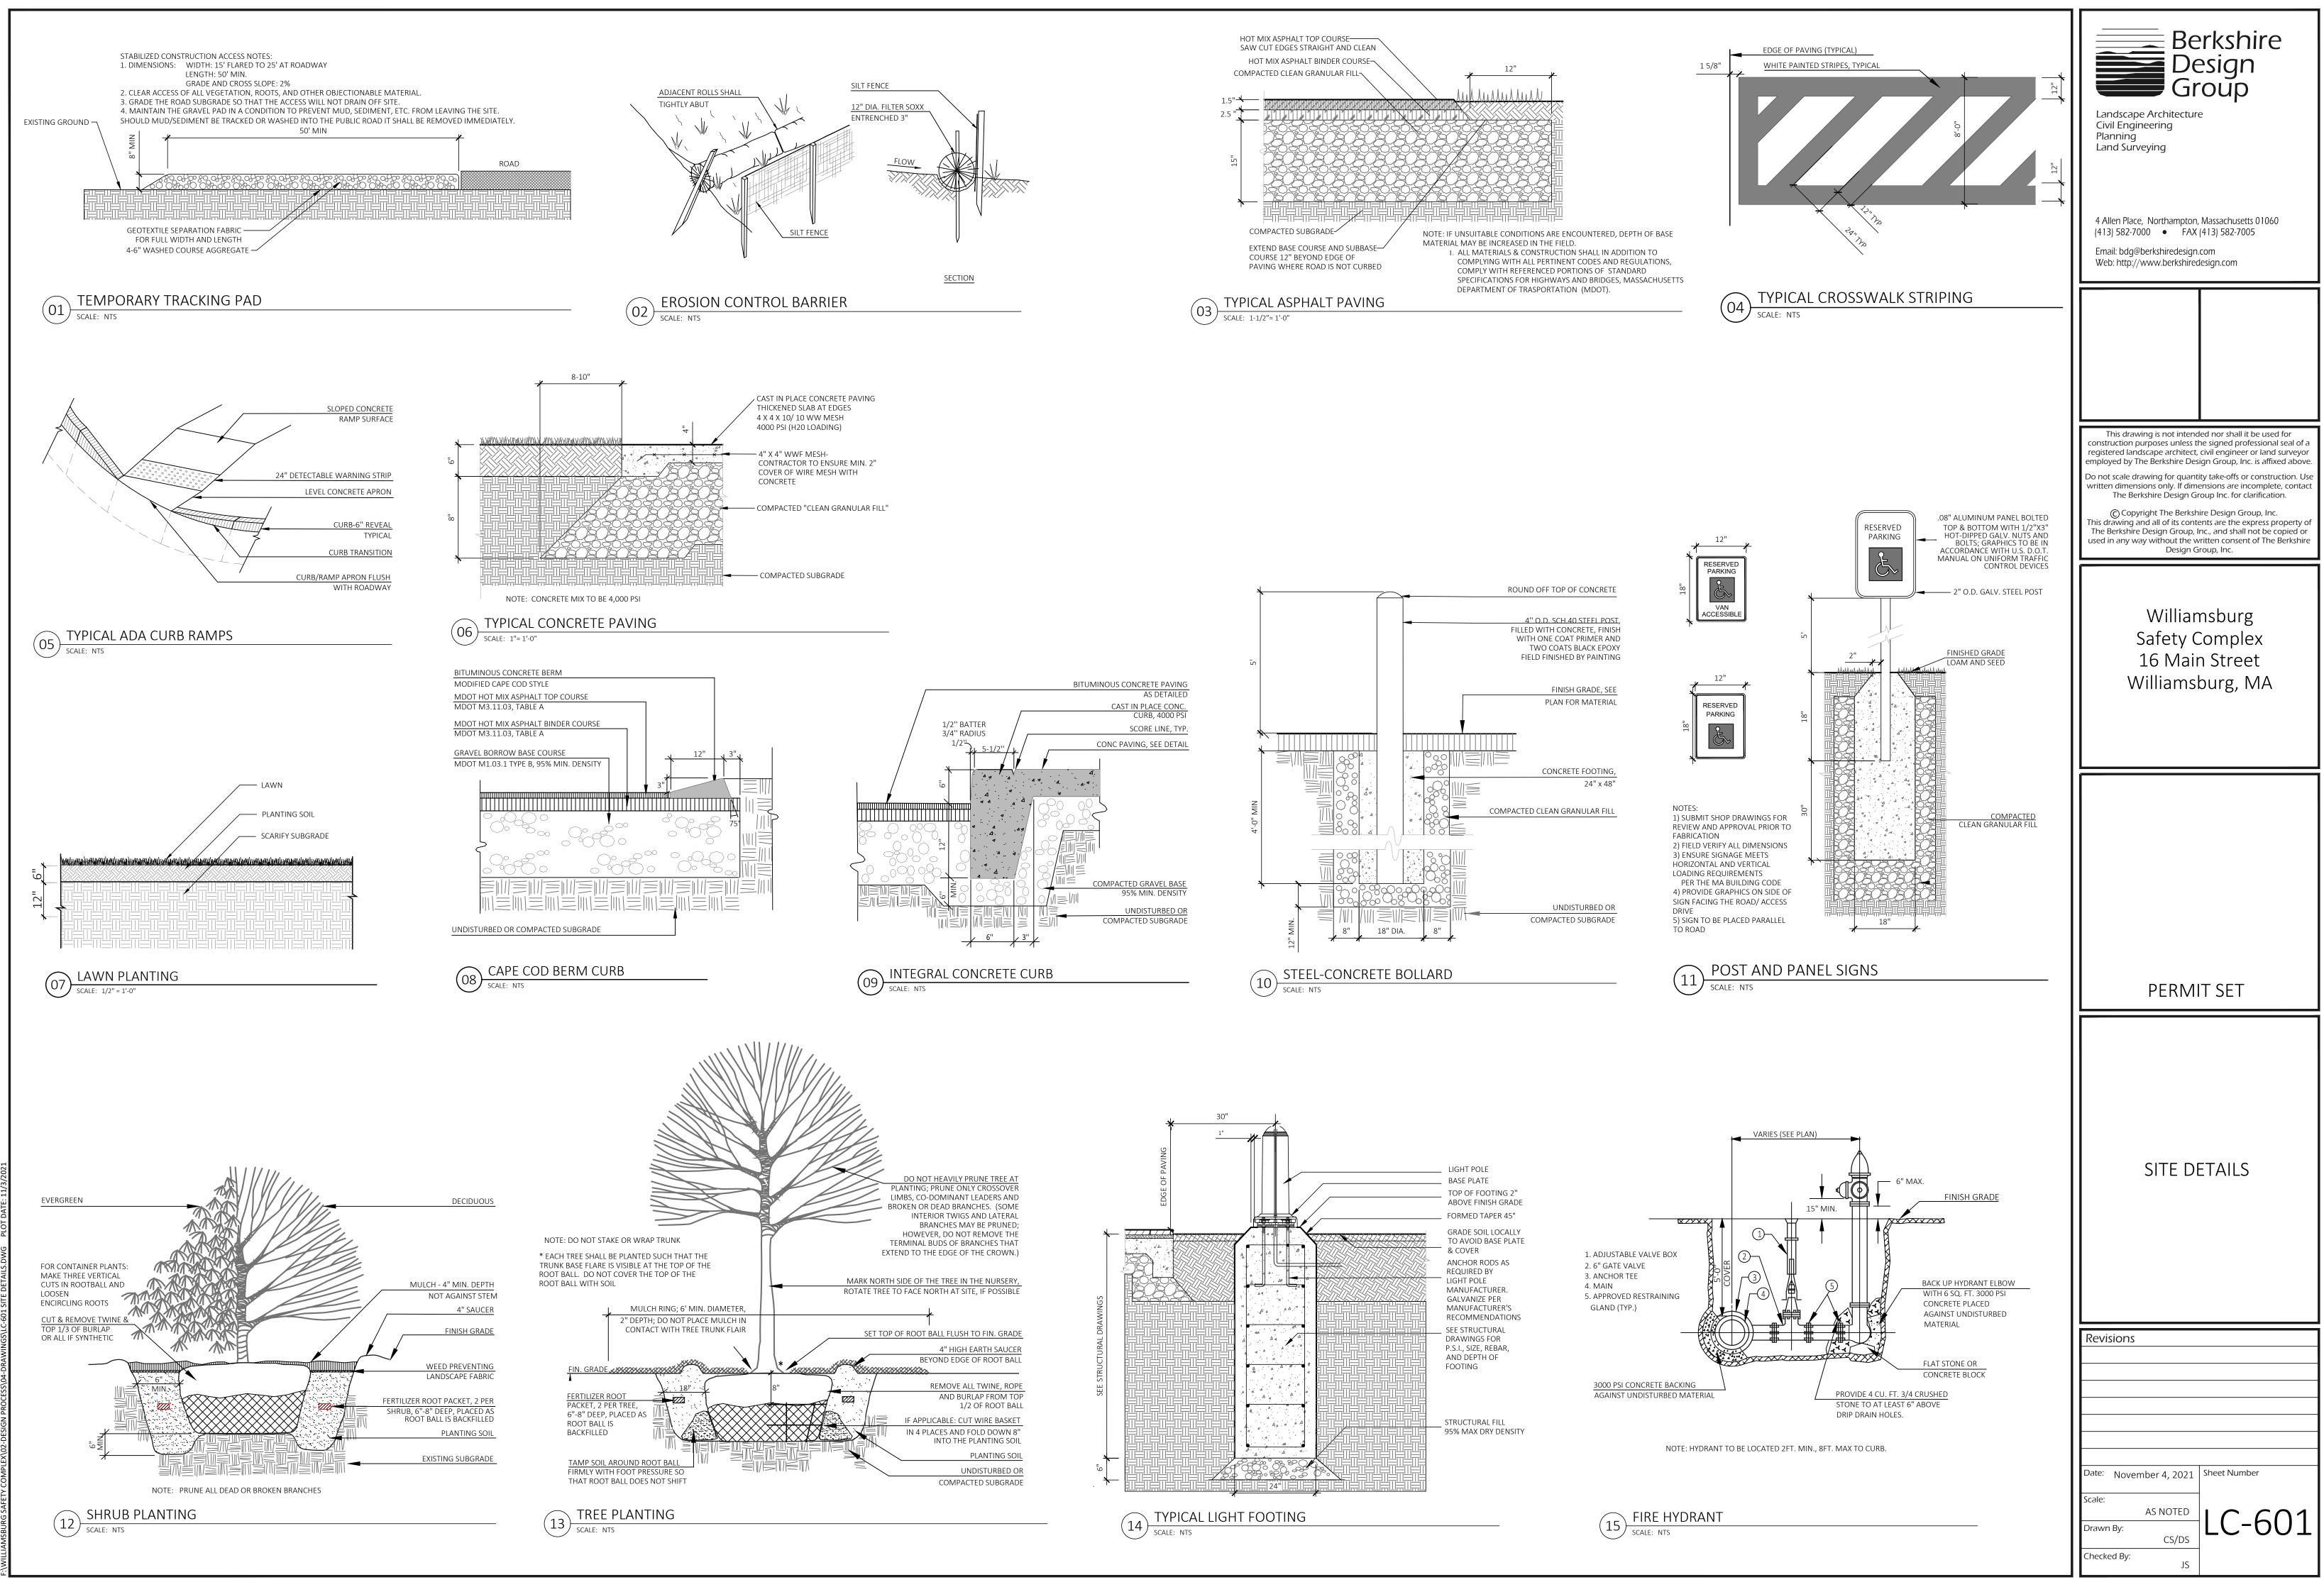
- LC-100 OVERALL EXISTING CONDITIONS PLAN
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- A3.1 **BUILDING ELEVATIONS EAST + WEST**

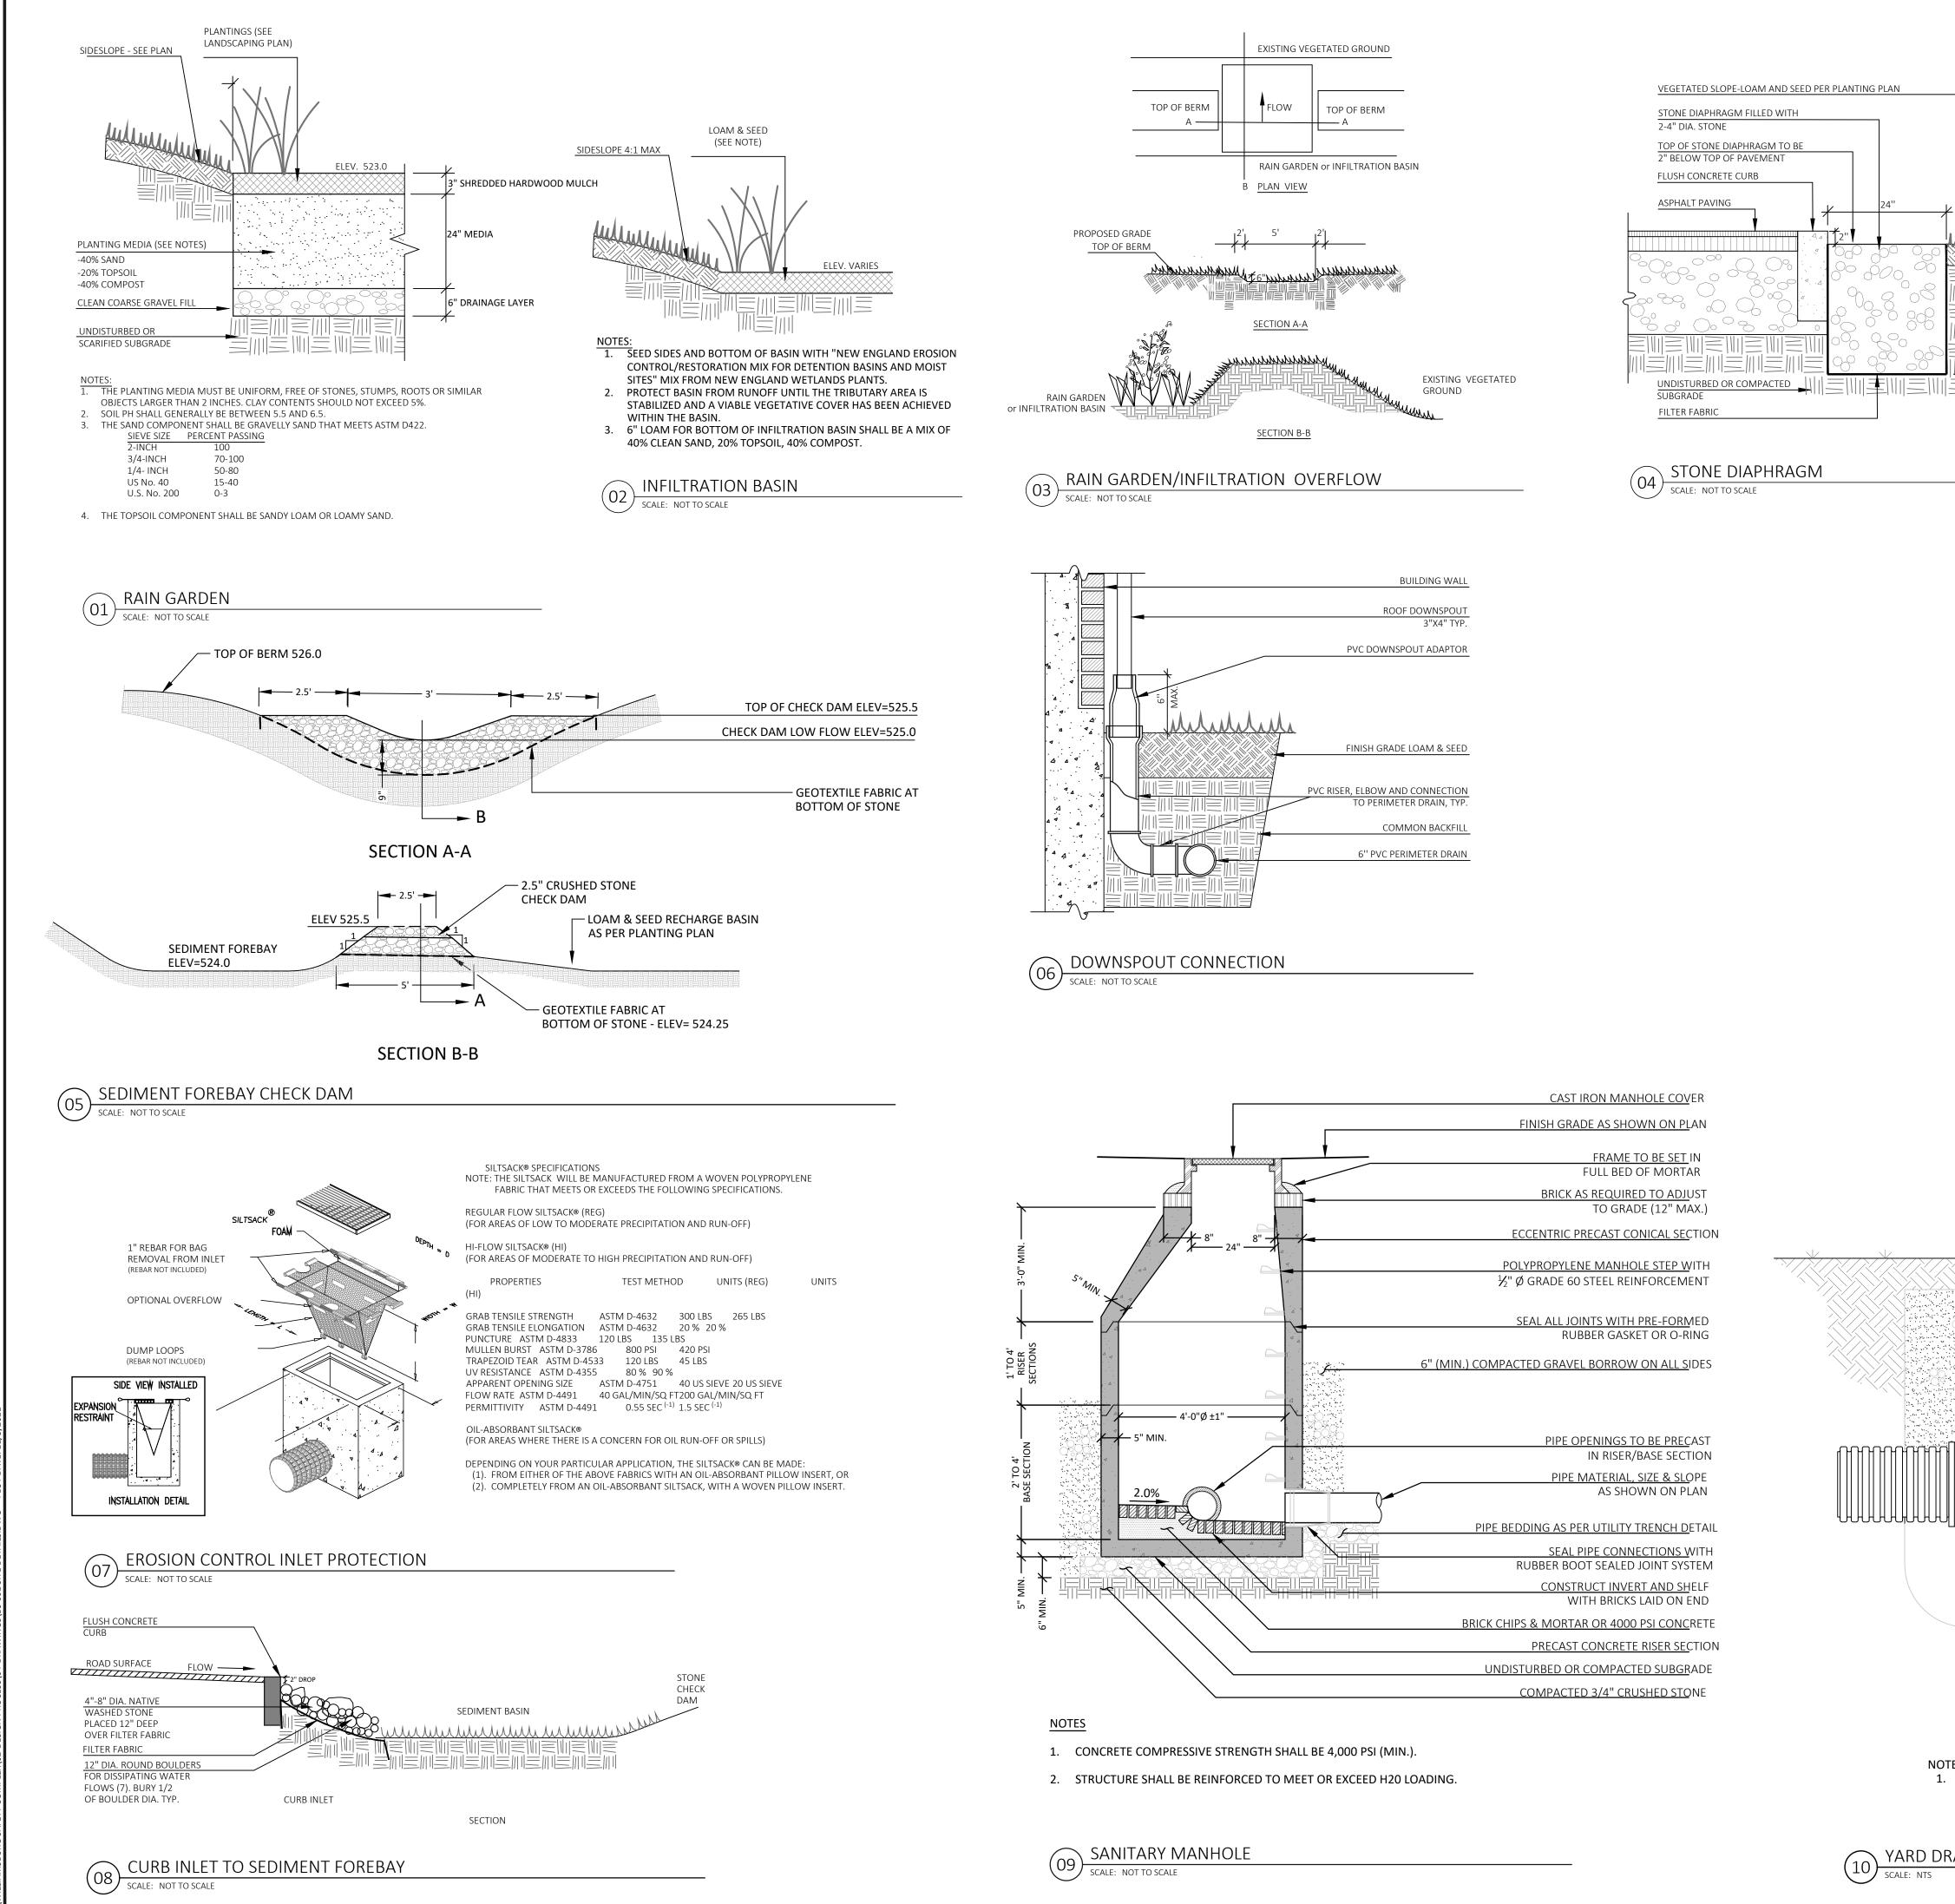






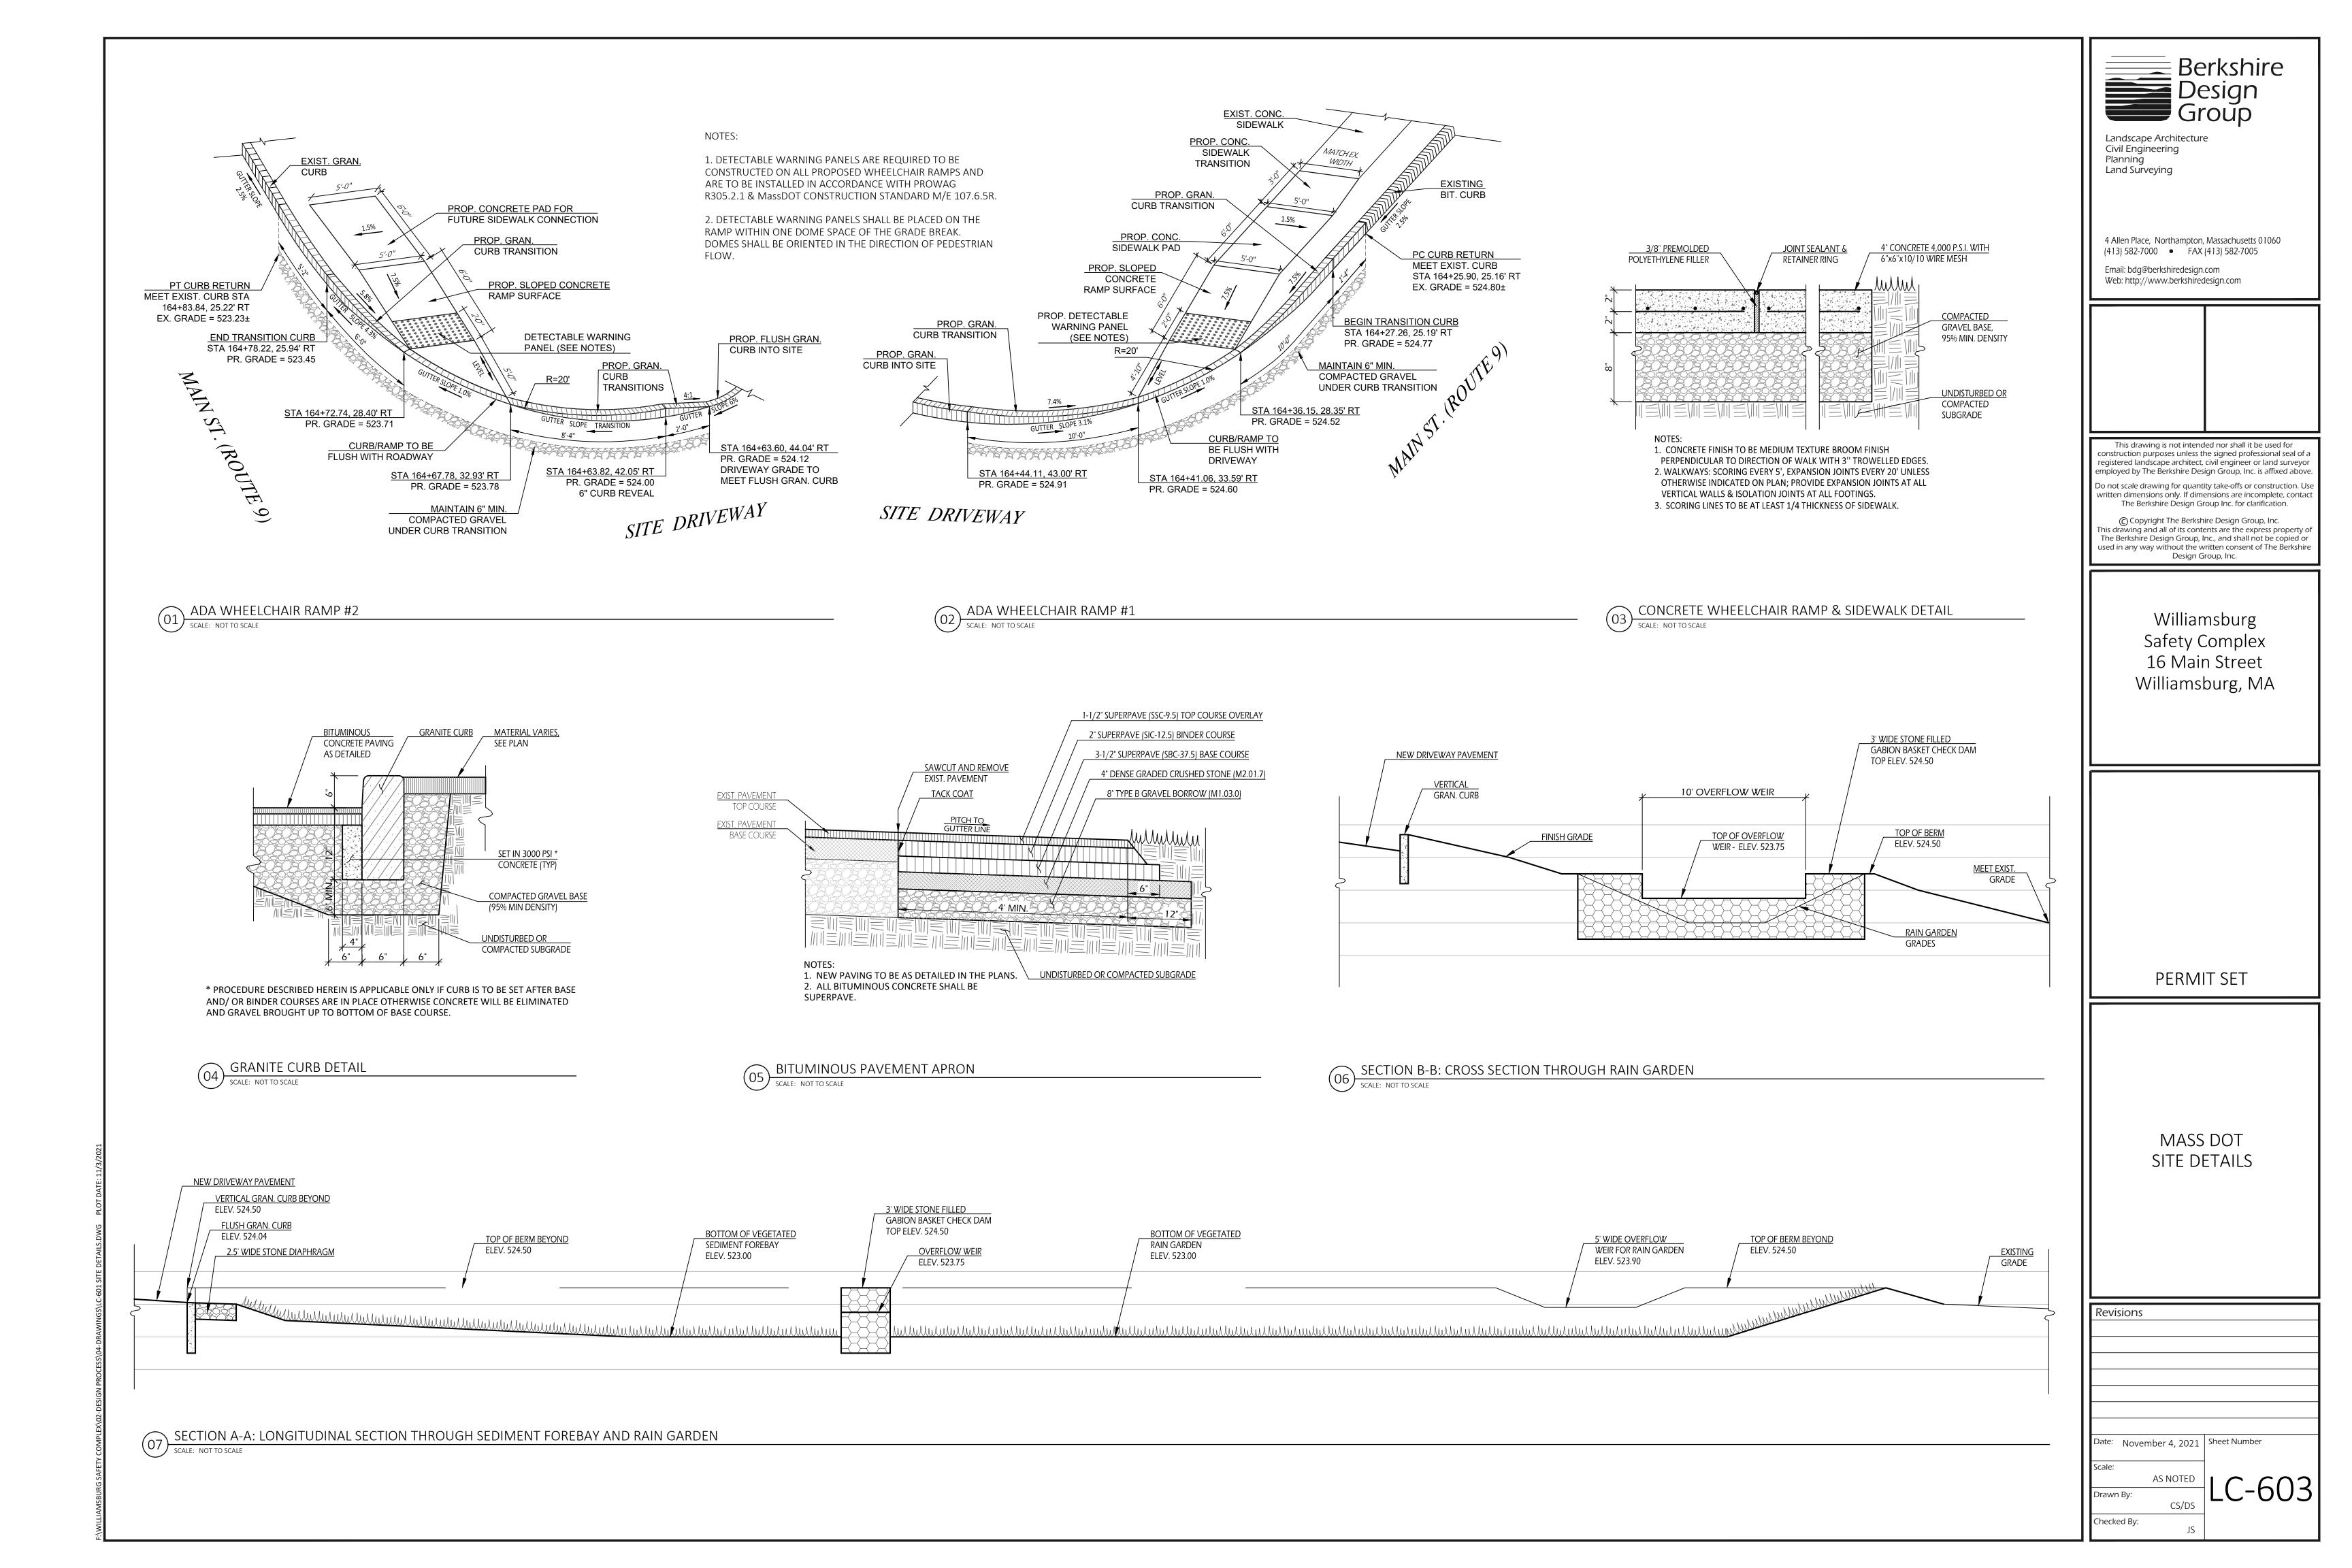


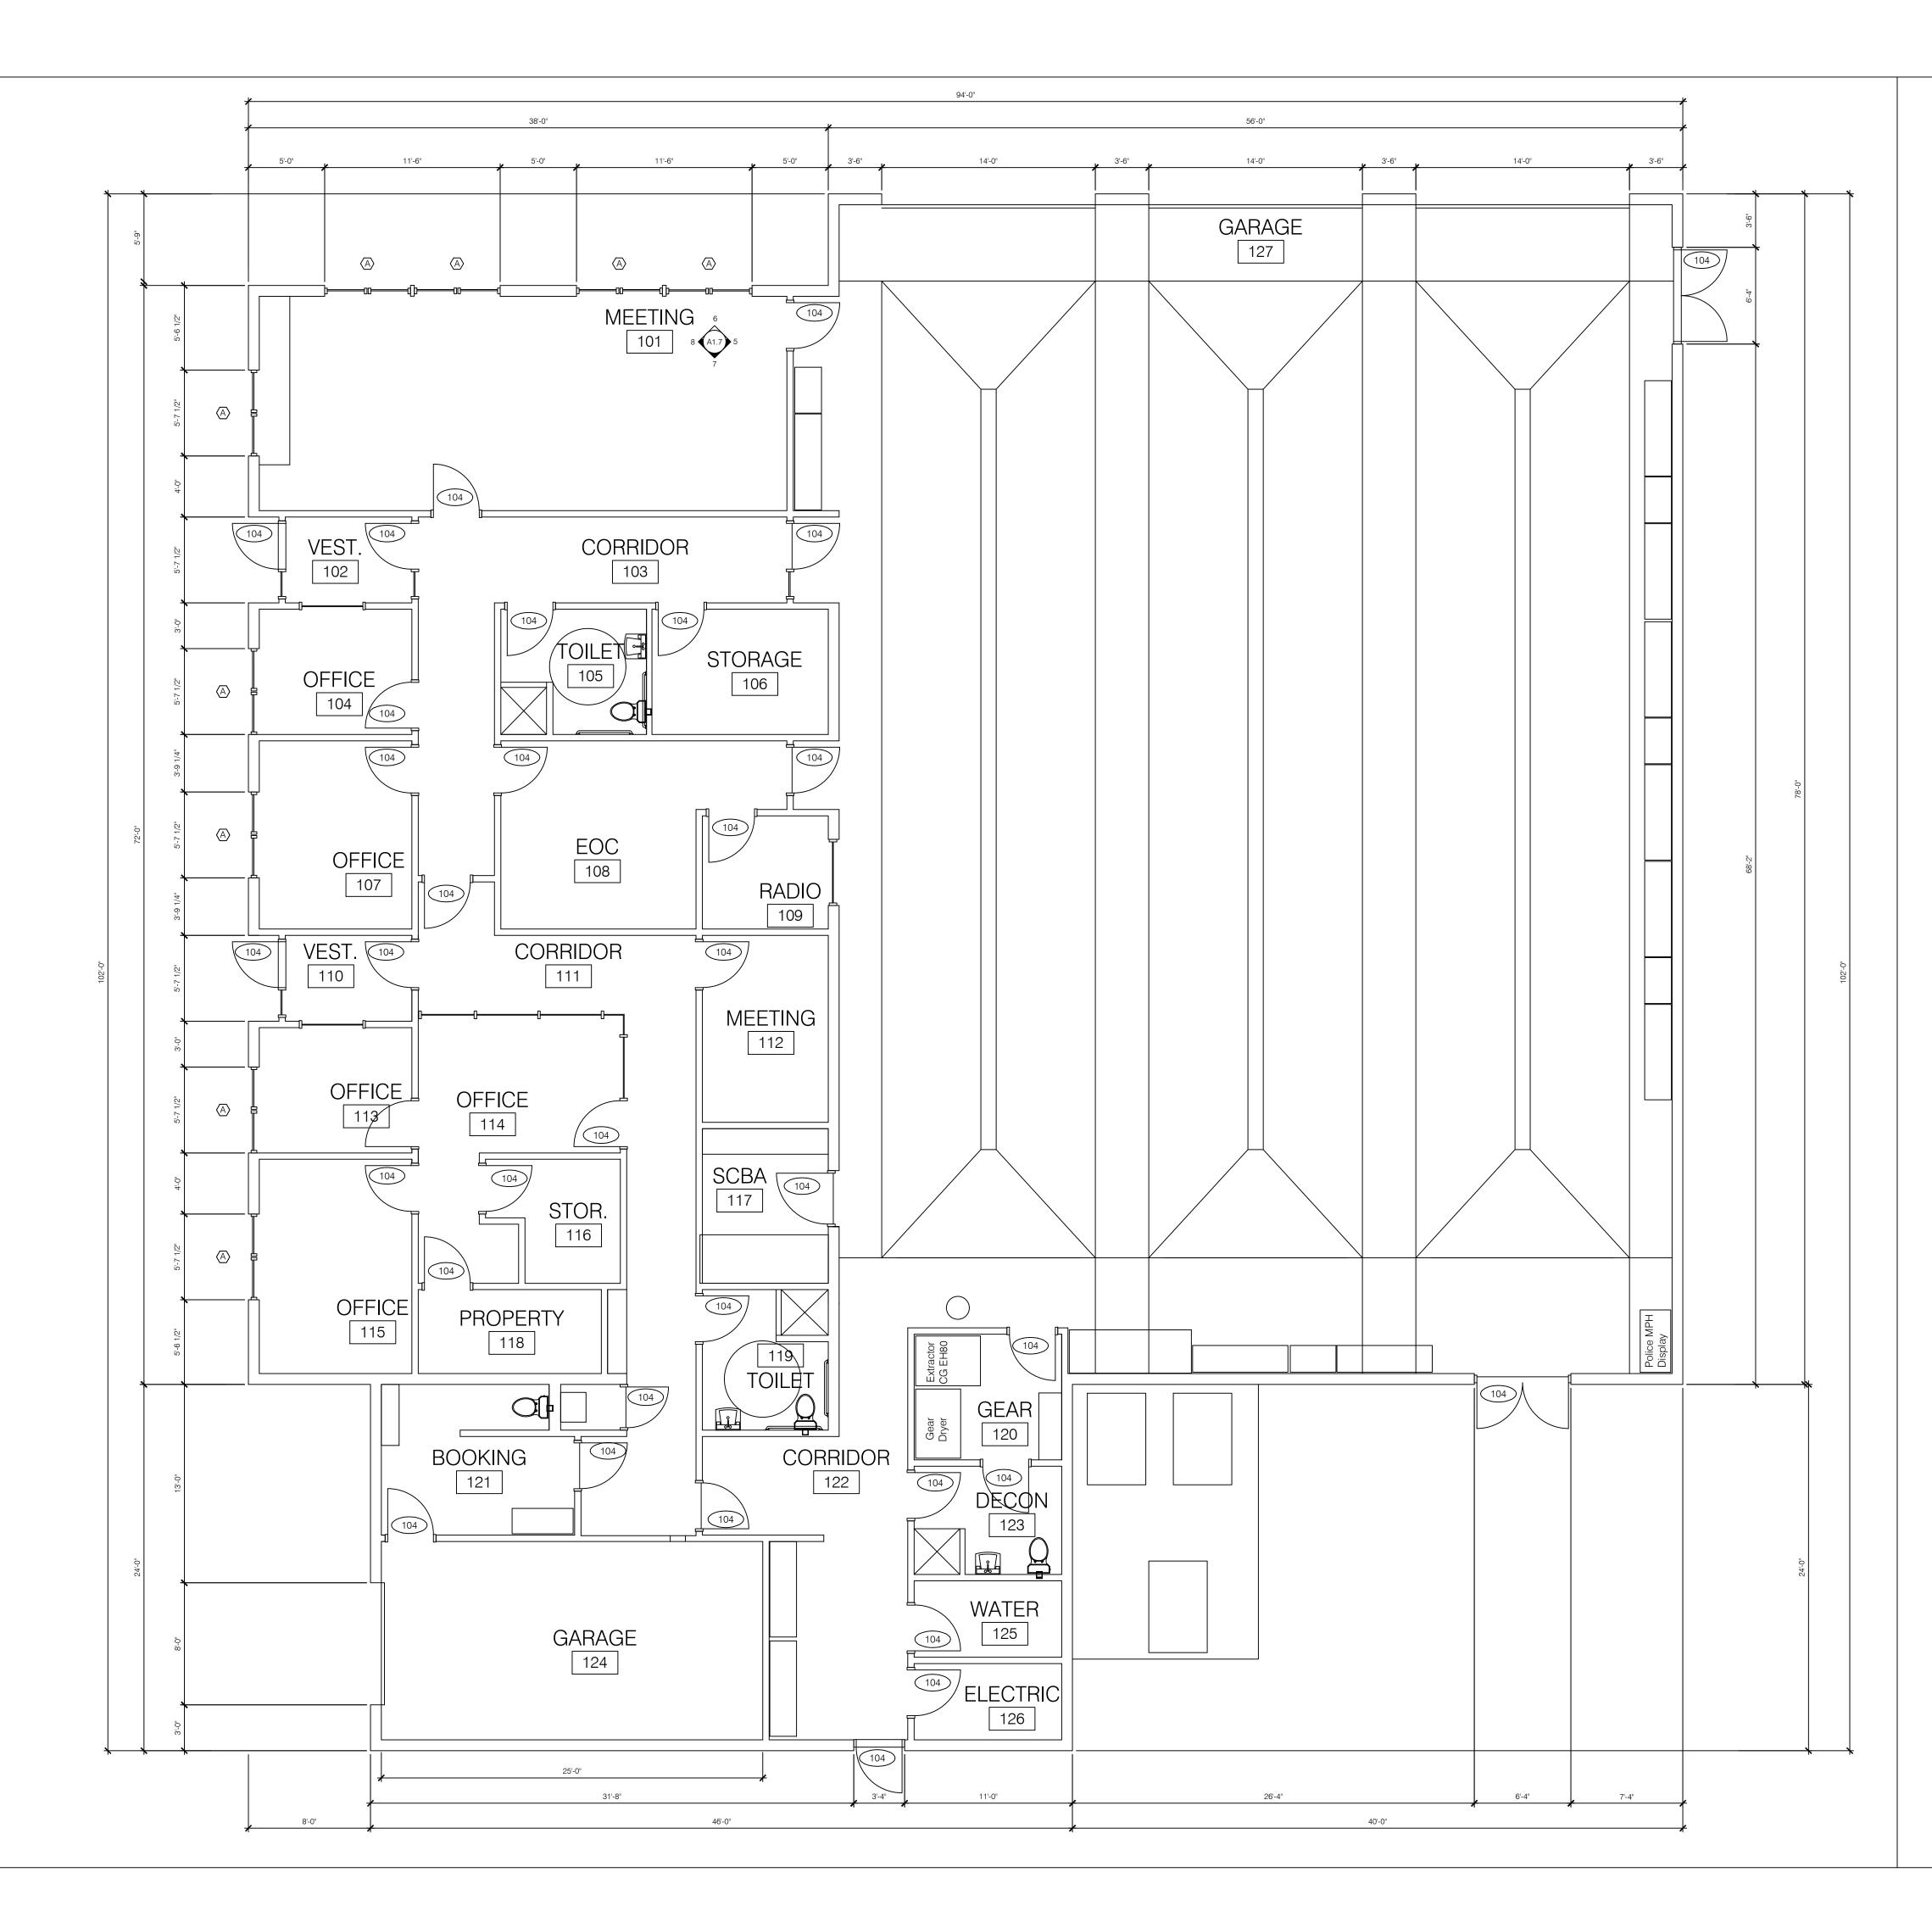




NOTE

	Berkshire      Berkshire      Design      Design
	This drawing is not intended nor shall it be used for construction purposes unless the signed professional seal of a registered landscape architect, civil engineer or land surveyor employed by The Berkshire Design Group, Inc. is affixed above. Do not scale drawing for quantity take-offs or construction. Use written dimensions only. If dimensions are incomplete, contact The Berkshire Design Group Inc. for clarification. © Copyright The Berkshire Design Group, Inc. This drawing and all of its contents are the express property of
	Williamsburg Safety Complex 16 Main Street Williamsburg Safety Complex 16 Main Street Williamsburg, MA
NYLOPLAST DUCTILE IRON FRAME & GRATE STANDARD (NON-PEDESTRIAN) GRATE FINISH GRADE AS SHOWN ON PLAN	PERMIT SET
GRAVEL BACKFILL MYLOPLAST DRAIN BASIN 18" DIAMETER	SITE DETAILS
G" (MIN.) G" (MIN.) COMPACTED 3/4" CRUSHED STONE UNDISTURBED OR COMPACTED SUBGRADE YARD DRAIN DESIGN BASED ON NYLOPLAST YARD DRAIN STRUCTURE. THE CONTRACTOR MAY SUBMIT AN ALTERNATIVE YARD DRAIN FOR REVIEW BY THE ENGINEER. SUBSTITUTE STRUCTURE SHALL MEET OR EXCEED THE QUALITY OF	Revisions
THE SPECIFIED STRUCTURE, IN THE OPINION OF THE ENGINEER.	Scale: AS NOTED Drawn By: CS/DS Checked By: JS





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AM Fogarty Associates Inc. Construction Cost Consultants

175 Derby Street Hingham, Massachusetts 02043

#### Williamsburg Public Safety Building

Main Street Williamsburg, MA

REVISIONS			
NO.	DATE	BY	REMARKS

SHEET TITLE

#### FIRST FLOOR PLAN 33% CD PHASE

DATE		October 4, 2021
SCALE		3/16" = 1'-0"
DRAW	N BY	KEVIN CHROBAK
CHECI	KED BY	KEVIN CHROBAK

SHEET NO.





#### **PROPOSED SOUTH ELEVATION**

TYPICAL ELEVATION NOTES

TYPICAL EXTERIOR ROOF ASSEMBLY 30 YEAR ASPHALT SHINGLE ON 30# FELT FULL EXTENT OF ROOF ON § CDX ROOF SHEATHING ON 288 ROOF TRUSSES AT 24° OC. TRUSS BRACING REQUIREMENTS BY TRUSS MFR WATERPROOF UNDERLAYMENT @ EAVES + RAKES 36" W.



2 PROPOSED NORTH ELEVATION Scale: 3/16" = 1'-0"

TYPICAL ELEVATION NOTES

TOP OF TRUSS ASSEMBLY

LIGHTNING PROTECTION SYSTEM AT RIDGES. ALL HORIZ. CABLING IN ATTIC TIED INTO GROUNDING RODS AT GRADE.

TYPICAL EXTERIOR ROOF ASSEMBLY 30 YEAR ASPHALT SHINGLE ON 30# FELT FULL EXTENT OF ROOF ON 🖁 CDX ROOF SHEATHING ON 2X8 ROOF TRUSSES AT 24" OC. TRUSS BRACING REQUIREMENTS BY TRUSS MFR INSERT WATERPROOF UNDERLAYMENT @ EAVES + JUNCTIONS

<u>TYPICAL SOUTHWEST FLAT ROOF ASSEMBLY</u> 60 MIL MECHANICALLY FASTENED EPDM MEMBRANE OVER  $\frac{1}{2}$ " GYP SHEATHING PROTECTION BOARD OVER 5" RIGID INSUL OVER § GYP SHEATHING THERMAL BARRIER OVER WD FRAMING

EL. 18' - 6 TRUSS BEARING

 $\frac{\text{TYPICAL EXTERIOR GARAGE DOORS}}{\text{ALUMINUM OVERHEAD DOORS WITH }_{2}^{\text{INSUL.}} \text{ GLASS}}$  LITES, BOTTOM LITES INSULATED PANELS.. \_\_\_\_\_ <u>EL. 14' - 0"</u> ₩INDOW HEAD

TYPICAL EXTERIOR SOUTH WALL ASSEMBLY STEEL SIDING OVER AIR BARRIER OVER 1/2" CDX WALL SHEATHING OVER 2X8 WOOD STUDS AT 16" OC W/ 4" CLOSED CELL INSULATION, 5/8" GYPSUM BOARD WITH A 8' HIGH PERIMETER FRP WAINSCOTING.

CAST IRON BOOT COLLECTOR AT DOWNSPOU JUNCTION WITH GRADE TO 48" BELOW GRADE TIED INTO PVC DRAIN LINES BELOW GRADE EL. 0' - 0" T.O. SLAB

TYPICAL FOUNDATION WALL ASSEMBLY REINFORCED CONCRETE FOUNDATION WALL TO SPREAD FOOTINGS. RUBBED FINISH AT EXPOSED SURFACES.

EL. 28' - 6" + RIDGE LINE

\_\_\_\_\_

\_\_\_\_\_\_ <u>EL. 11' - 2"</u>

EL. 8' - 3" O.H. DOOR HEAD

TOP OF FDTN EL. 0' - 0" TOP OF SLAB

EL. -4' - 0" BTM. OF FDTN.

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#### Williamsburg Public Safety Building

Main Street Williamsburg, MA

REVISIONS NO. DATE RV REMARKS

#### SHEET TITLE

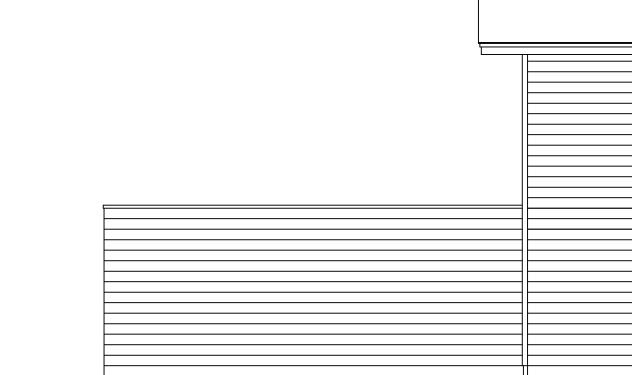
### **BUILDING ELEVATIONS** SOUTH + NORTH

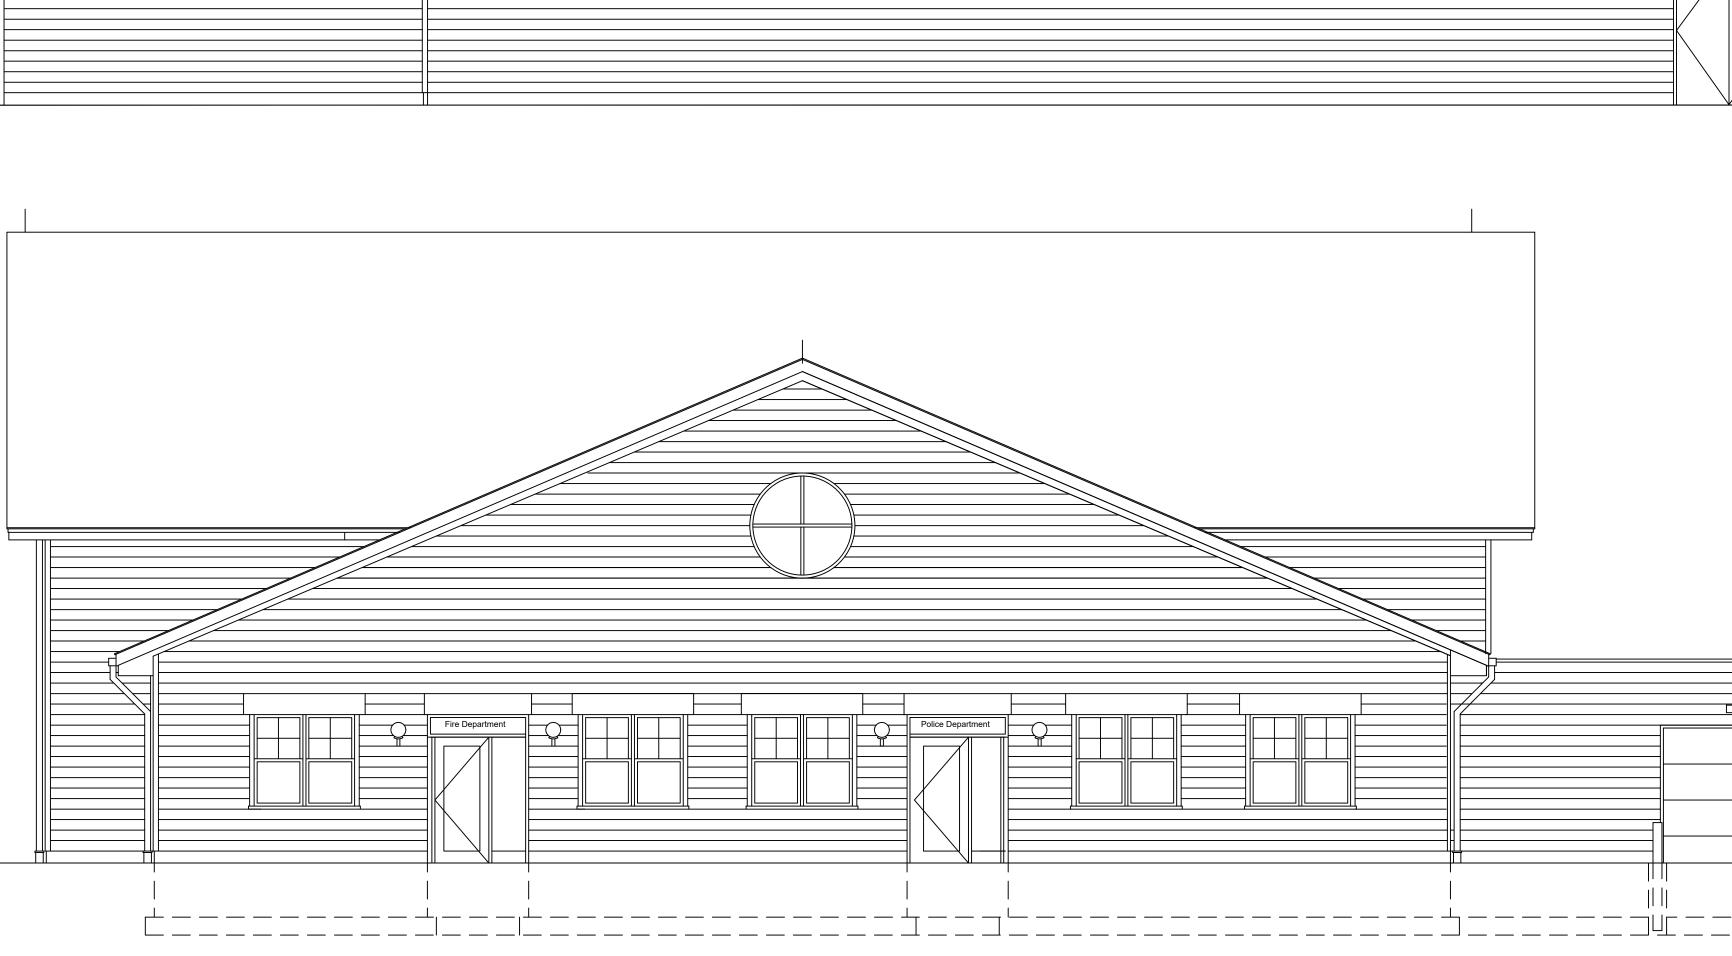
### 33% CD PHASE

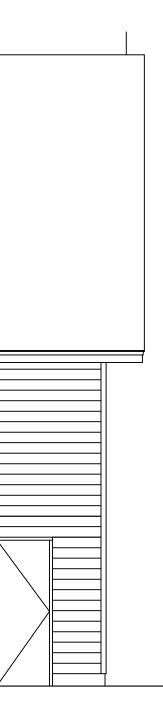
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SCALE	3/16" = 1'-0"
DRAWN BY	KEVIN CHROBAK
CHECKED BY	KEVIN CHROBAK

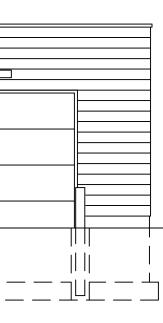
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Main Street Williamsburg, MA

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SHEET TITLE

### BUILDING ELEVATIONS EAST + WEST

DATE	September 22, 2021
SCALE	3/16" = 1'-0"
DRAWN BY	KEVIN CHROBAK
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