

ZPII-222 SOLAR ARRAY 95 MAIN STREET (ASSESSOR'S MAP G - LOTS 75 & 76) -PERMIT SITE PLANS-

MODULES	DC POWER	AC POWER
10,900	4.2±MW	3.0±MW



WILLIAMSBURG, MASSACHUSETTS

DATE: OCTOBER 3, 2018 REVISED: DECEMBER 6, 2018 REVISED: JANUARY 4, 2019 REVISED: JANUARY 17, 2019 REVISED: JANUARY 25, 2019

APPLICANT:

ZPT ENERGY SOLUTIONS II, LLC 6 PARK AVENUE, SUITE 100, LOWER LEVEL WORCESTER, MASSACHUSETTS 01605

RECORD OWNERS:

LAWRENCE & LINDA WEST 95 MAIN STREET HAYDENVILLE, MASSACHUSETTS 01039



LAND SURVEYOR/SITE CIVIL ENGINEER:

ENVIRONMENTAL CONSULTANT:



LEC ENVIRONMENTAL CONSULTANTS, INC. 100 GROVE STREET, SUITE 302 WORCESTER, MA 01605 WWW.LECENVIRONMENTAL.COM

DRAWING INDEX:

SHEET 1 SHEET 2	COVER SHEET & LOCUS CONTEXT MAP RECORD CONDITIONS PLAN OF LAND	APPROVED BY: WILLIAMSBURG PLANNING
SHEET 3	PERMIT SITE OVERVIEW	BOARD
SHEET 4	PERMIT SITE LAYOUT	
SHEET 5	GRADING & UTILITY PLAN 1	
SHEET 6	GRADING & UTILITY PLAN 2	
SHEET 7	BASIN DETAIL 1	
SHEET 8	BASIN DETAIL 2	
SHEET 9	PHASING PLAN	
SHEET 10	EROSION & SEDIMENT PLAN 1	
SHEET 11	EROSION & SEDIMENT PLAN 2	
SHEET 12	EROSION & SEDIMENT NOTES	
SHEET 13	DETAIL SHEET	APPROVED BY: WILLIAMSBURG ZONING BOARD OF APPEALS
	CLERK OF THE TOWN OF WILLIAMSRUPS	
	I,	

"THIS PLAN IS SUBJECT TO A SPECIAL PERMIT DATED _____

TOWN CLERK


DATE

FOR PERMITTING ONLY

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GRAPHIC SCALE SCALE: 1"=250'


"THIS PLAN IS SUBJECT TO A SITE PLAN REVIEW DATED _____

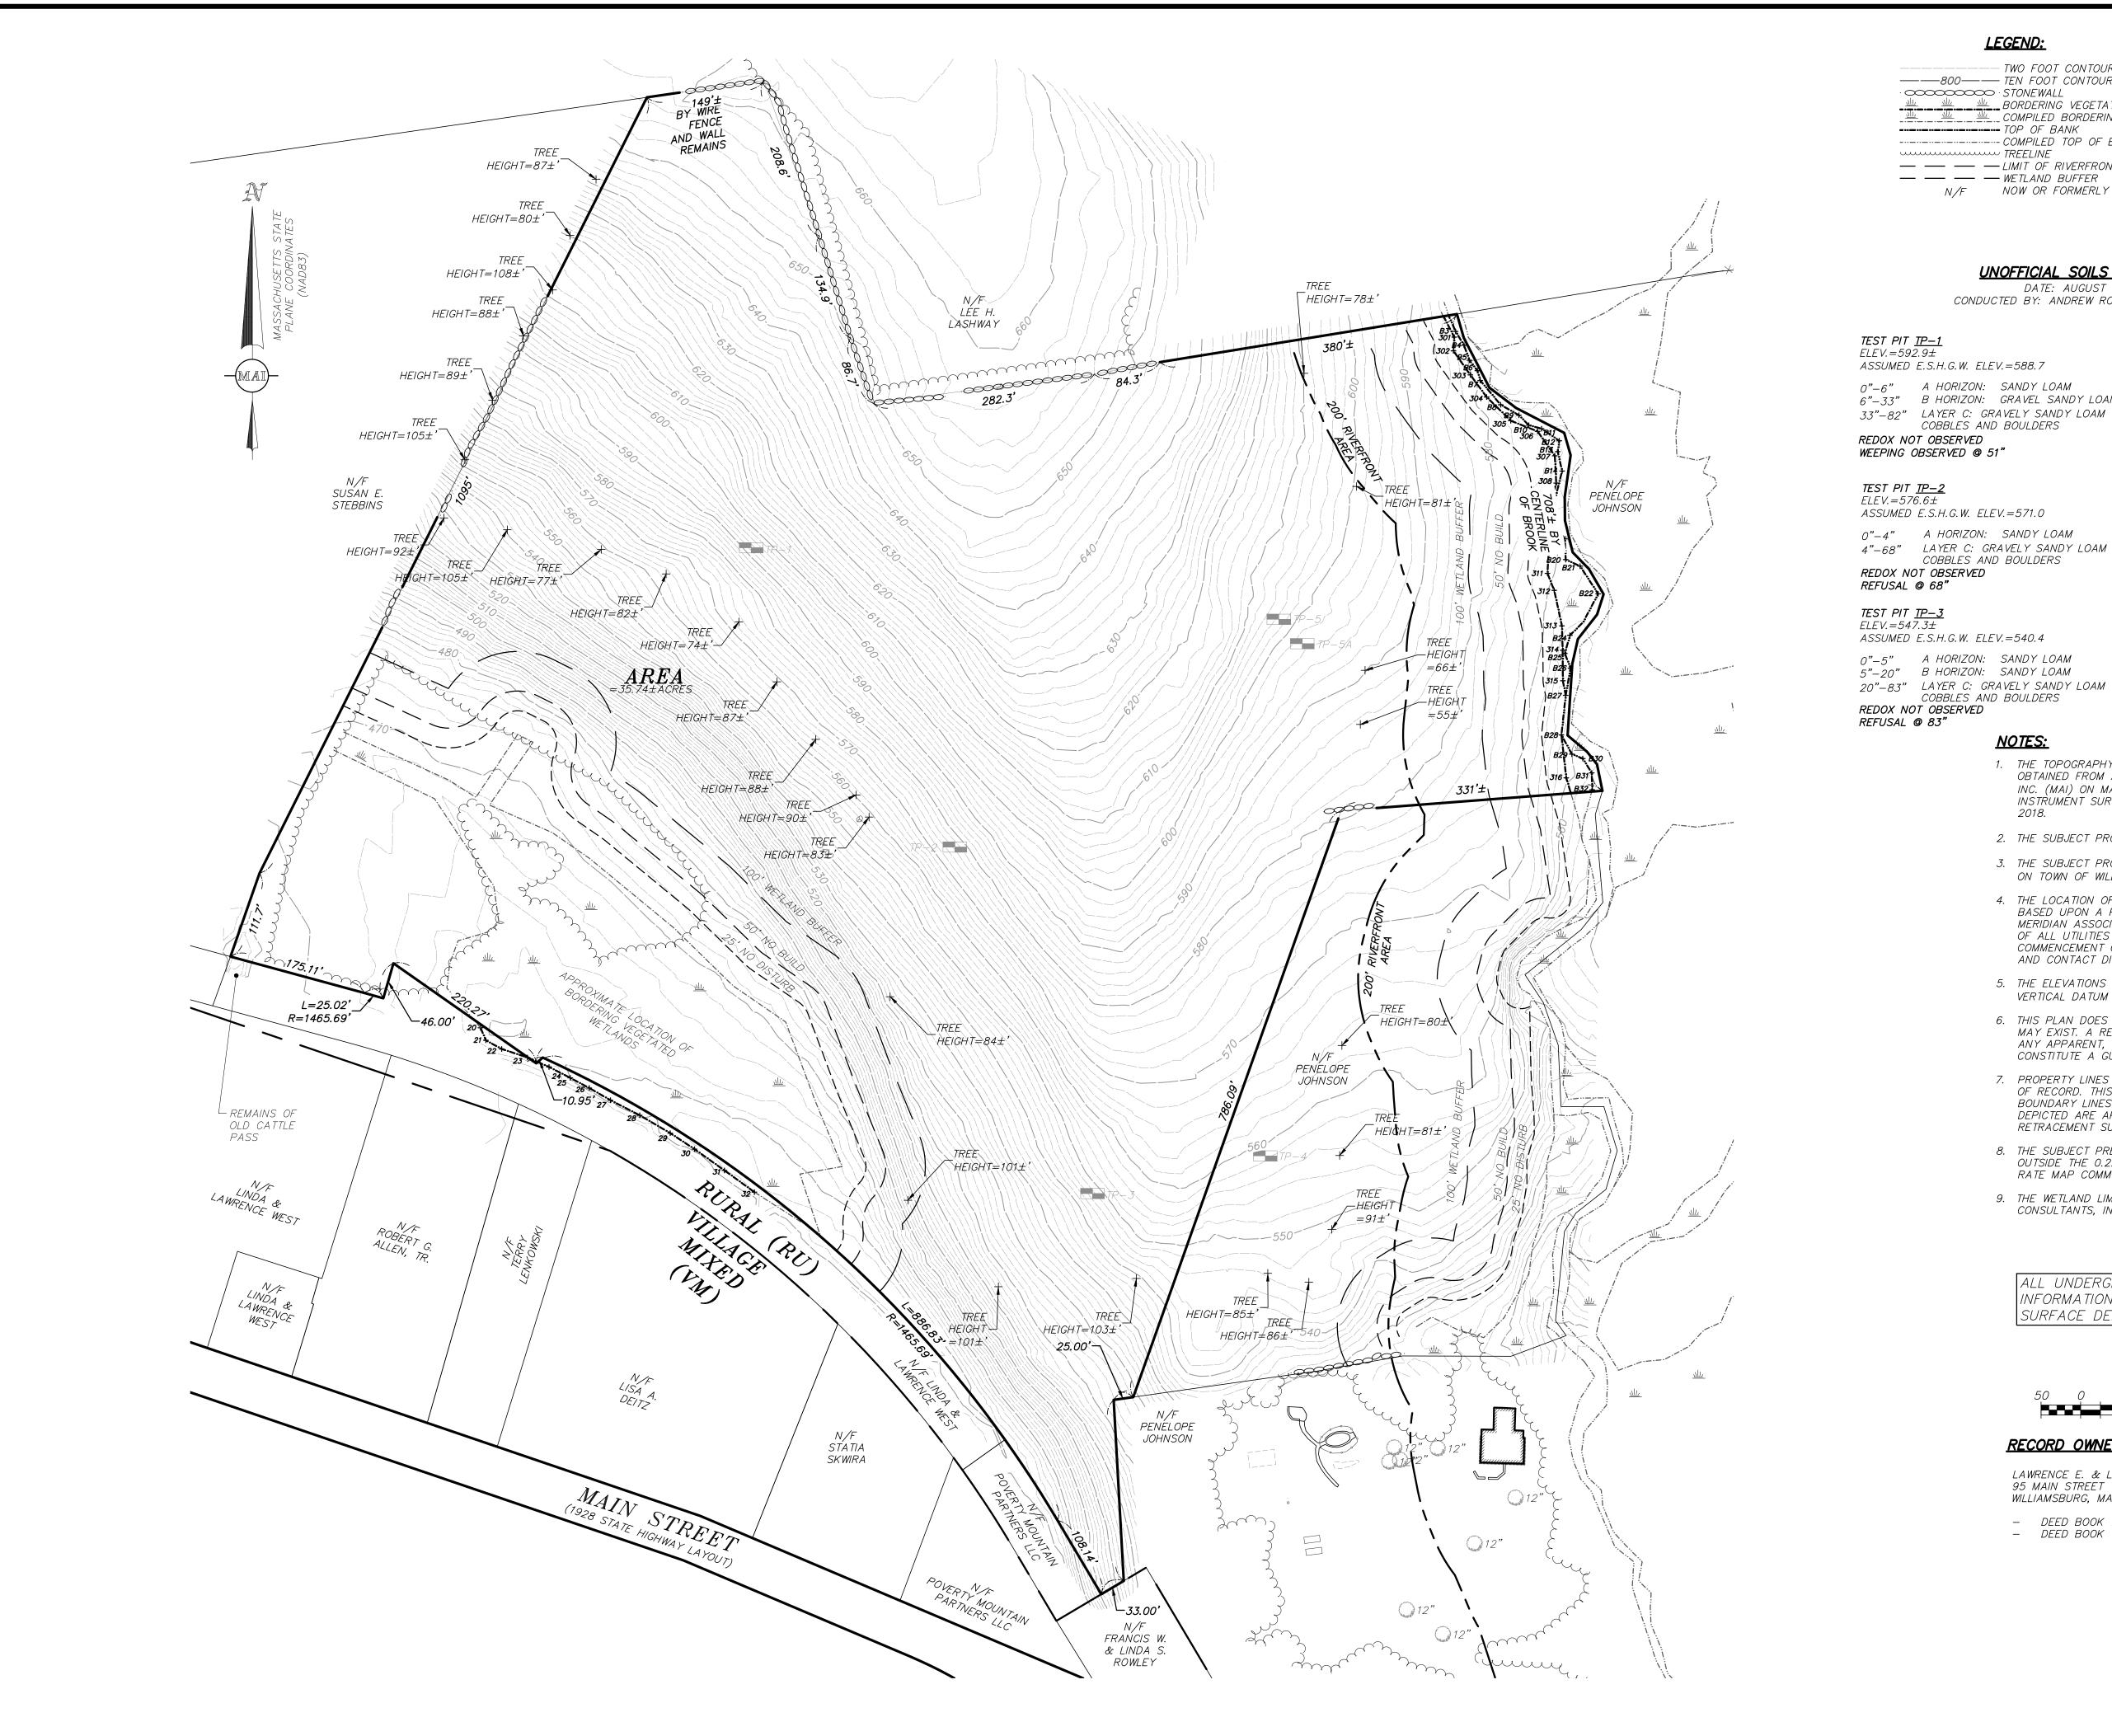

TWO FOOT CONTOUR

· STONEWALL BORDERING VEGETATED WETLANDS ----- TOP OF BANK

----- COMPILED TOP OF BANK TREELINE — — LIMIT OF RIVERFRONT BUFFER — — WETLAND BUFFER N/F NOW OR FORMERLY

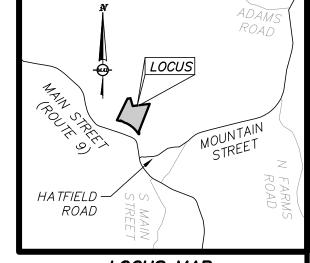

(1"=5000')

UNOFFICIAL SOILS INFORMATION

DATE: AUGUST 14, 2018 CONDUCTED BY: ANDREW RODRIGUEZ, SE (13890)

0"-6" A HORIZON: SANDY LOAM 6"-33" B HORIZON: GRAVEL SANDY LOAM 33"-82" LAYER C: GRAVELY SANDY LOAM

ASSUMED E.S.H.G.W. ELEV.=571.0 0"-4" A HORIZON: SANDY LOAM

COBBLES AND BOULDERS

ASSUMED E.S.H.G.W. ELEV.=540.4

5"-20" B HORIZON: SANDY LOAM 20"-83" LAYER C: GRAVELY SANDY LOAM COBBLES AND BOULDERS

1. THE TOPOGRAPHY, SITE DETAIL & SURFACE IMPROVEMENTS DEPICTED HEREON WERE OBTAINED FROM AN AERIAL LIDAR SURVEY CONDUCTED BY MERIDIAN ASSOCIATES, INC. (MAI) ON MARCH 28, 2018 AND SUPPLEMENTED WITH AN ON-THE-GROUND INSTRUMÉNT SURVEY CONDUCTED BY MERIDIAN ASSOCIATES, INC. ON MAY 8-10,

REDOX NOT OBSERVED

WEEPING OBSERVED @ 18"

TEST PIT <u>TP-4</u>

REDOX NOT OBSERVED

REDOX NOT OBSERVED

TEST PIT <u>TP-5A</u>

 $ELEV. = 596.9 \pm$

WEEPING OBSERVED @ 38"

TEST PIT <u>TP-5</u>

ELEV.=603.4±

WEEPING OBSERVED @ 48"

ASSUMED E.S.H.G.W. ELEV.=554.4

ASSUMED E.S.H.G.W. ELEV.=600.3

ASSUMED E.S.H.G.W. ELEV.=595.4

0"-6" A HORIZON: SANDY LOAM

6"-18+" LAYER C: GRAVELY SANDY LOAM COBBLES AND BOULDERS

0"-6" A HORIZON: SANDY LOAM

6"-30" B HORIZON: SANDY LOAM

0"-6" A HORIZON: SANDY LOAM

6"-21" B HORIZON: GRAVELY SANDY LOAM

COBBLES AND BOULDERS

30"-51" LAYER C: GREY SOIL, GRAVELY SANDY

LOAM COBBLES AND BOULDERS

21"-58" LAYER C: GRAVELY SANDY LOAM

ELEV.=558.4±

- 2. THE SUBJECT PROPERY IS LOCATED IN THE RURAL (RU) ZONING DISTRICT.
- 3. THE SUBJECT PROPERTY IS DEPICTED AS MAP G LOTS 75 & 76 (95 MAIN STREET) ON TOWN OF WILLIAMSBURG ASSESSOR'S MAPS.
- 4. THE LOCATION OF ALL UNDERGROUND UTILITIES SHOWN ARE APPROXIMATE AND ARE BASED UPON A PARTIAL FIELD SURVEY AND COMPILATION OF PLANS OF RECORD. MERIDIAN ASSOCIATES, INC. DOES NOT WARRANTY NOR GUARANTEE THE LOCATION OF ALL UTILITIES DEPICTED OR NOT DEPICTED. THE CONTRACTOR, PRIOR TO COMMENCEMENT OF CONSTRUCTION, SHALL VERIFY THE LOCATION OF ALL UTILITIES AND CONTACT DIG SAFE AT 1-888-344-7233.
- 5. THE ELEVATIONS DEPICTED HEREON WERE BASED ON THE NORTH AMERICAN VERTICAL DATUM OF 1988 (NAVD 88).
- 6. THIS PLAN DOES NOT SHOW ANY UNRECORDED OR UNWRITTEN EASEMENTS WHICH MAY EXIST. A REASONABLE AND DILIGENT ATTEMPT HAS BEEN MADE TO OBSERVE ANY APPARENT, VISIBLE USES OF THE LAND; HOWEVER, THIS DOES NOT CONSTITUTE A GUARANTEE THAT NO SUCH EASEMENTS EXIST.
- 7. PROPERTY LINES DEPICTED HEREON ARE BASED ON COMPILED DEEDS AND PLANS OF RECORD. THIS PLAN IS NOT TO BE USED FOR THE RECONSTRUCTION OF BOUNDARY LINES OR FOR TITLE INSURANCE PURPOSES. ALL BOUNDARY LINES DEPICTED ARE APPROXIMATE ONLY. MAI DID NOT PERFORM A BOUNDARY RETRACEMENT SURVEY.
- 8. THE SUBJECT PREMISES IS LOCATED IN FLOOD ZONE C, AREAS DETERMINED TO BE OUTSIDE THE 0.2% ANNUAL CHANCE FLOODPLAIN PER FEMA FLOOD INSURANCE RATE MAP COMMUNITY-PANEL NUMBER 2501740002B DATED JUNE 1, 1981.
- 9. THE WETLAND LIMITS DEPICTED WERE DEMARCATED BY LEC ENVIRONMENTAL CONSULTANTS, INC. ON FEBRUARY 13, FEBRUARY 28, AND APRIL 9, 2018.

ALL UNDERGROUND UTILITY DATA REPRESENTS RECORD INFORMATION RECOVERED THROUGH RESEARCH WITHOUT SURFACE DEMARCATION NOR SUBSURFACE VERIFICATION.

GRAPHIC SCALE SCALE: 1"= 100' 0 50 100

REFERENCES:

RECORD OWNERS:

LAWRENCE E. & LINDA A. WEST 95 MAIN STREET WILLIAMSBURG, MASSACHUSETTS 01096

- DEED BOOK 7762, PAGE 195
- DEED BOOK 12308, PAGE 108
- PLAN BOOK 164 PLAN 34 - PLAN BOOK 167 PLAN 79 PLAN BOOK 213, PLAN 53 - PLAN BOOK 218 PLAN 102 - PLAN BOOK 205 PLAN 6 - PLAN BOOK 205 PLAN 7

- PLAN BOOK 34, PLAN 38

- PLAN BOOK 71, PLAN 37

- PLAN BOOK 79, PLAN 10

- PLAN BOOK 236, PLAN 93

- 1928 STATE HIGHWAY LAYOUT #2537

DOCUMENTS ON RECORD AT THE HAMPSHIRE DISTRICT REGISTRY OF DEEDS.

DWG. NO. 6091_REC(WEST)-1.DW

BK. #672, PG. #69

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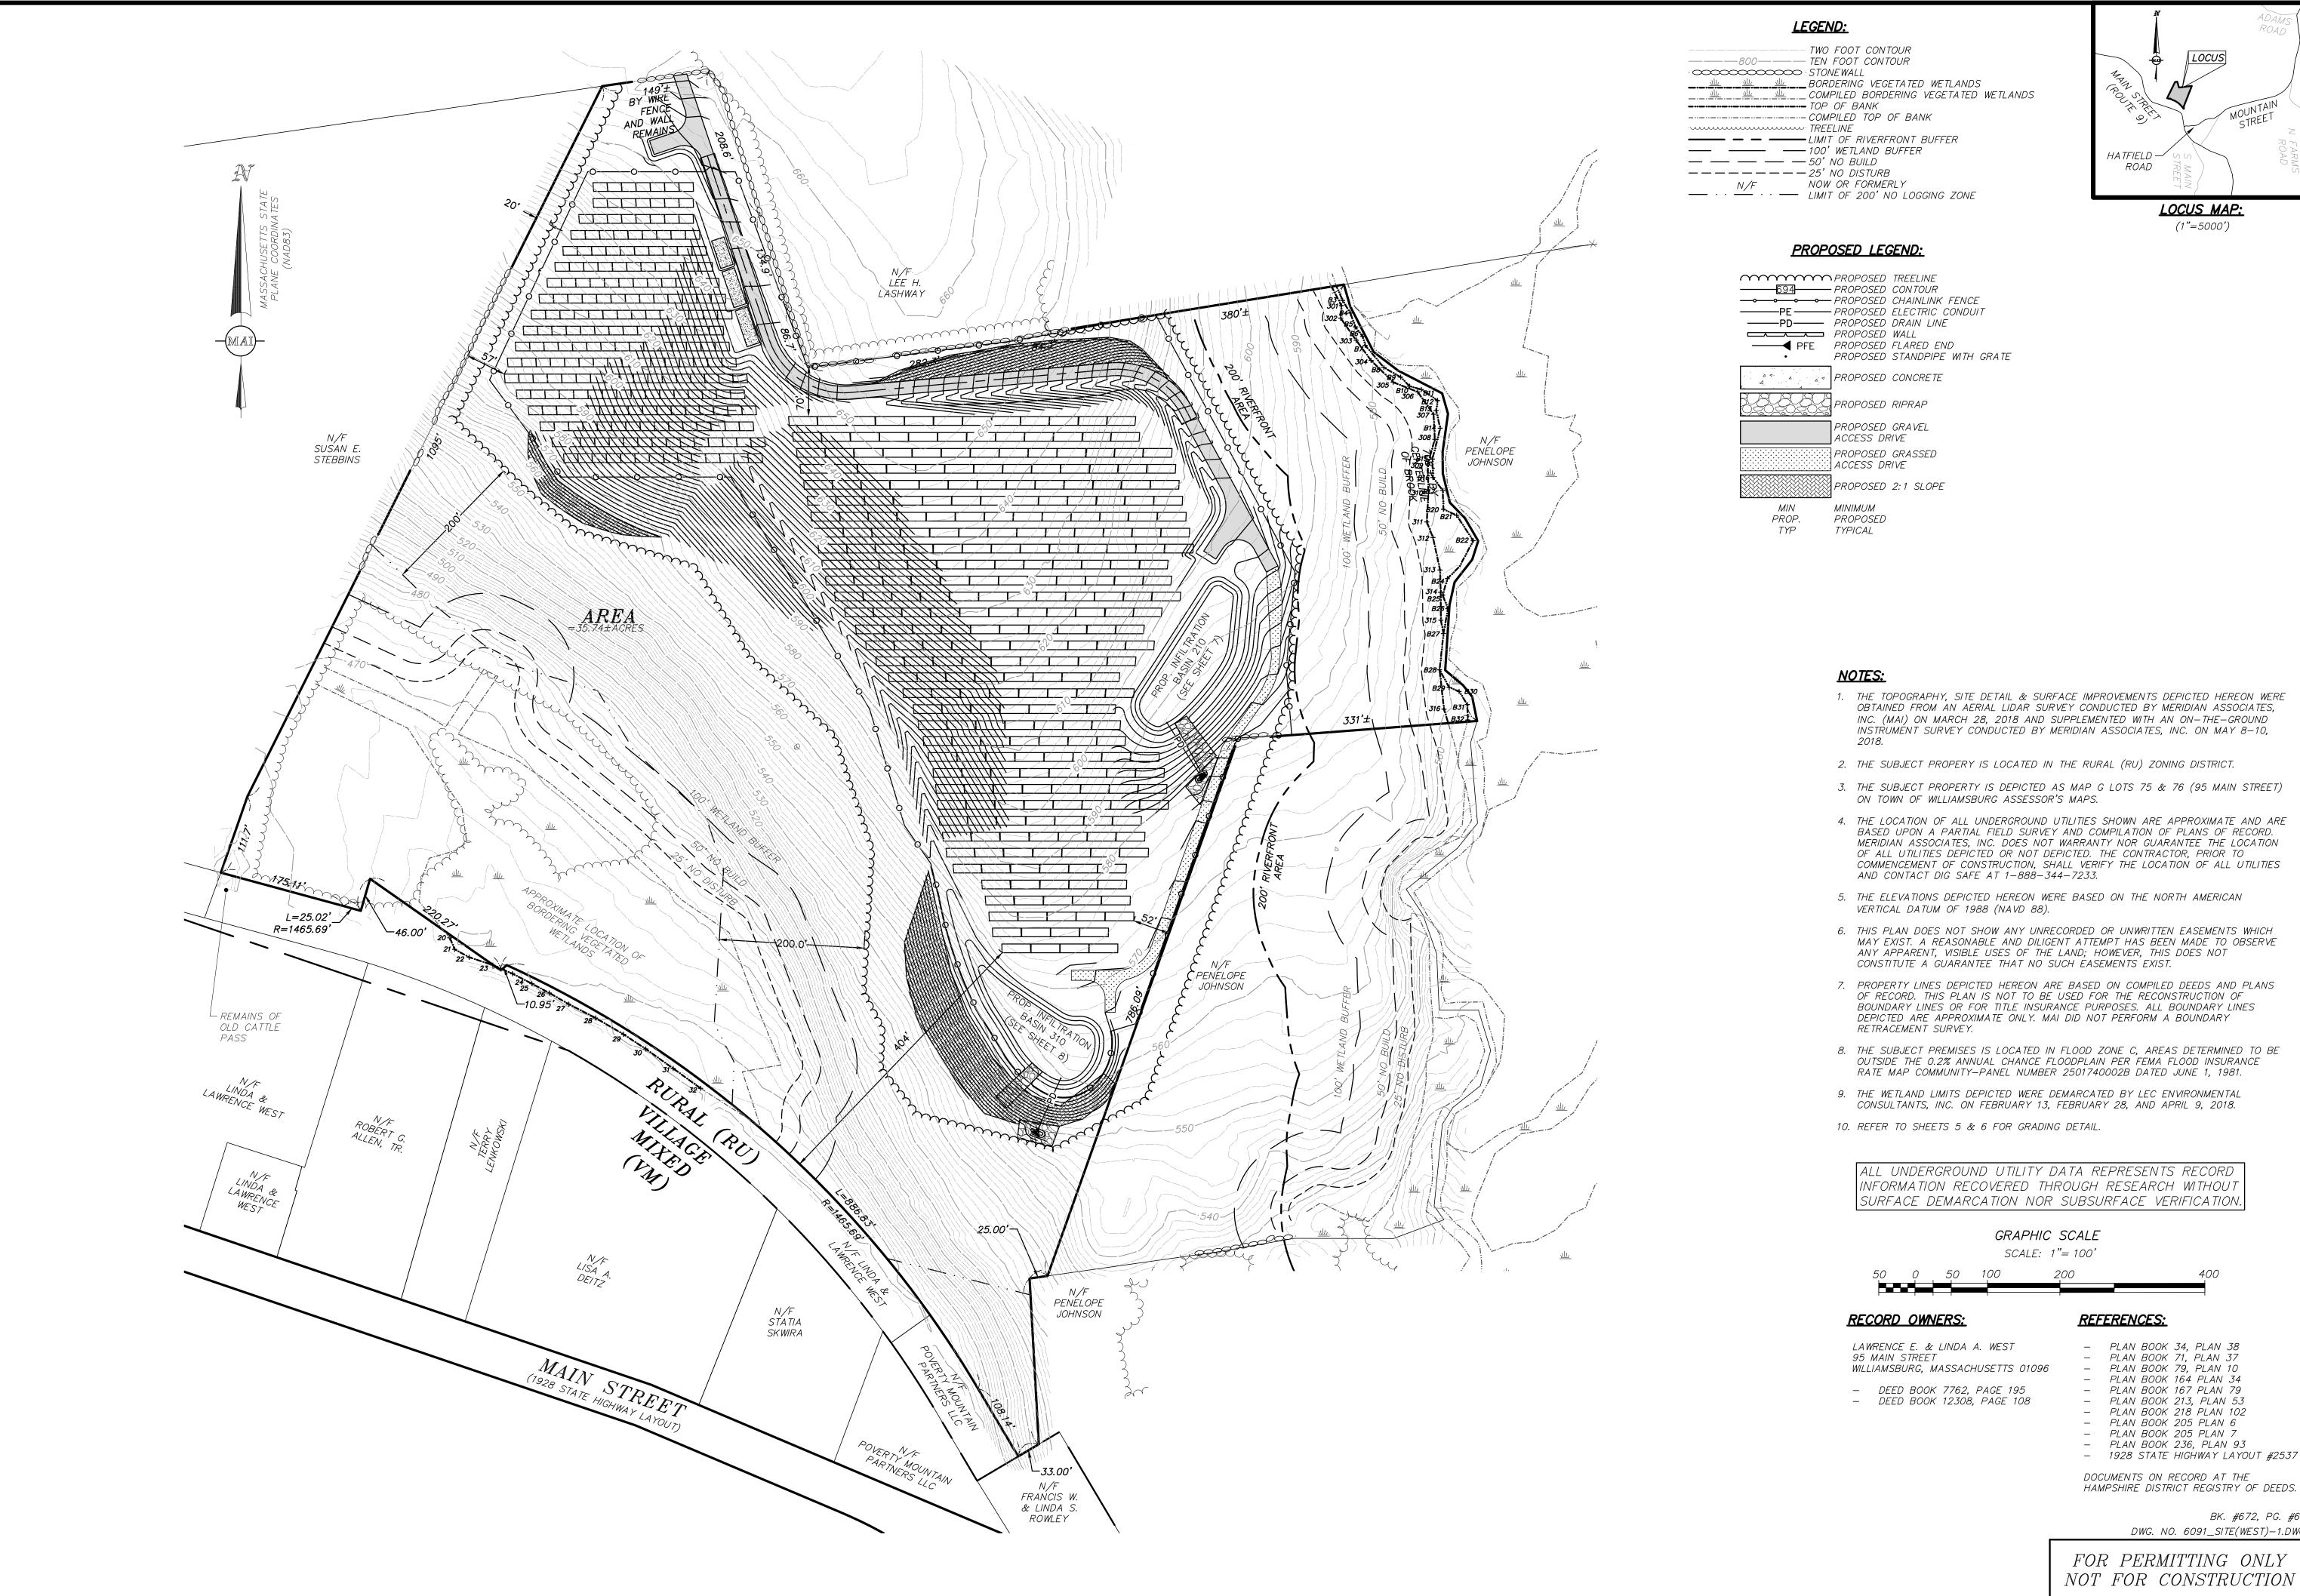
LOCUS MAP:



JANUARY 1, 2019


1"= 100' SHEET No.

2 of 13 PROJECT No.



HATFIELD -ROAD

LOCUS MAP:

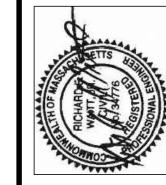

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- PLAN BOOK 34, PLAN 38 - PLAN BOOK 71, PLAN 37 - PLAN BOOK 79, PLAN 10 - PLAN BOOK 164 PLAN 34

- PLAN BOOK 167 PLAN 79 - PLAN BOOK 213, PLAN 53 - PLAN BOOK 218 PLAN 102 - PLAN BOOK 205 PLAN 6 - PLAN BOOK 205 PLAN 7

DOCUMENTS ON RECORD AT THE HAMPSHIRE DISTRICT REGISTRY OF DEEDS.

> BK. #672, PG. #69 DWG. NO. 6091_SITE(WEST)-1.DW

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(1"=5000')





JANUARY 1, 2019


1"=100'


3 of 13


PROJECT No.

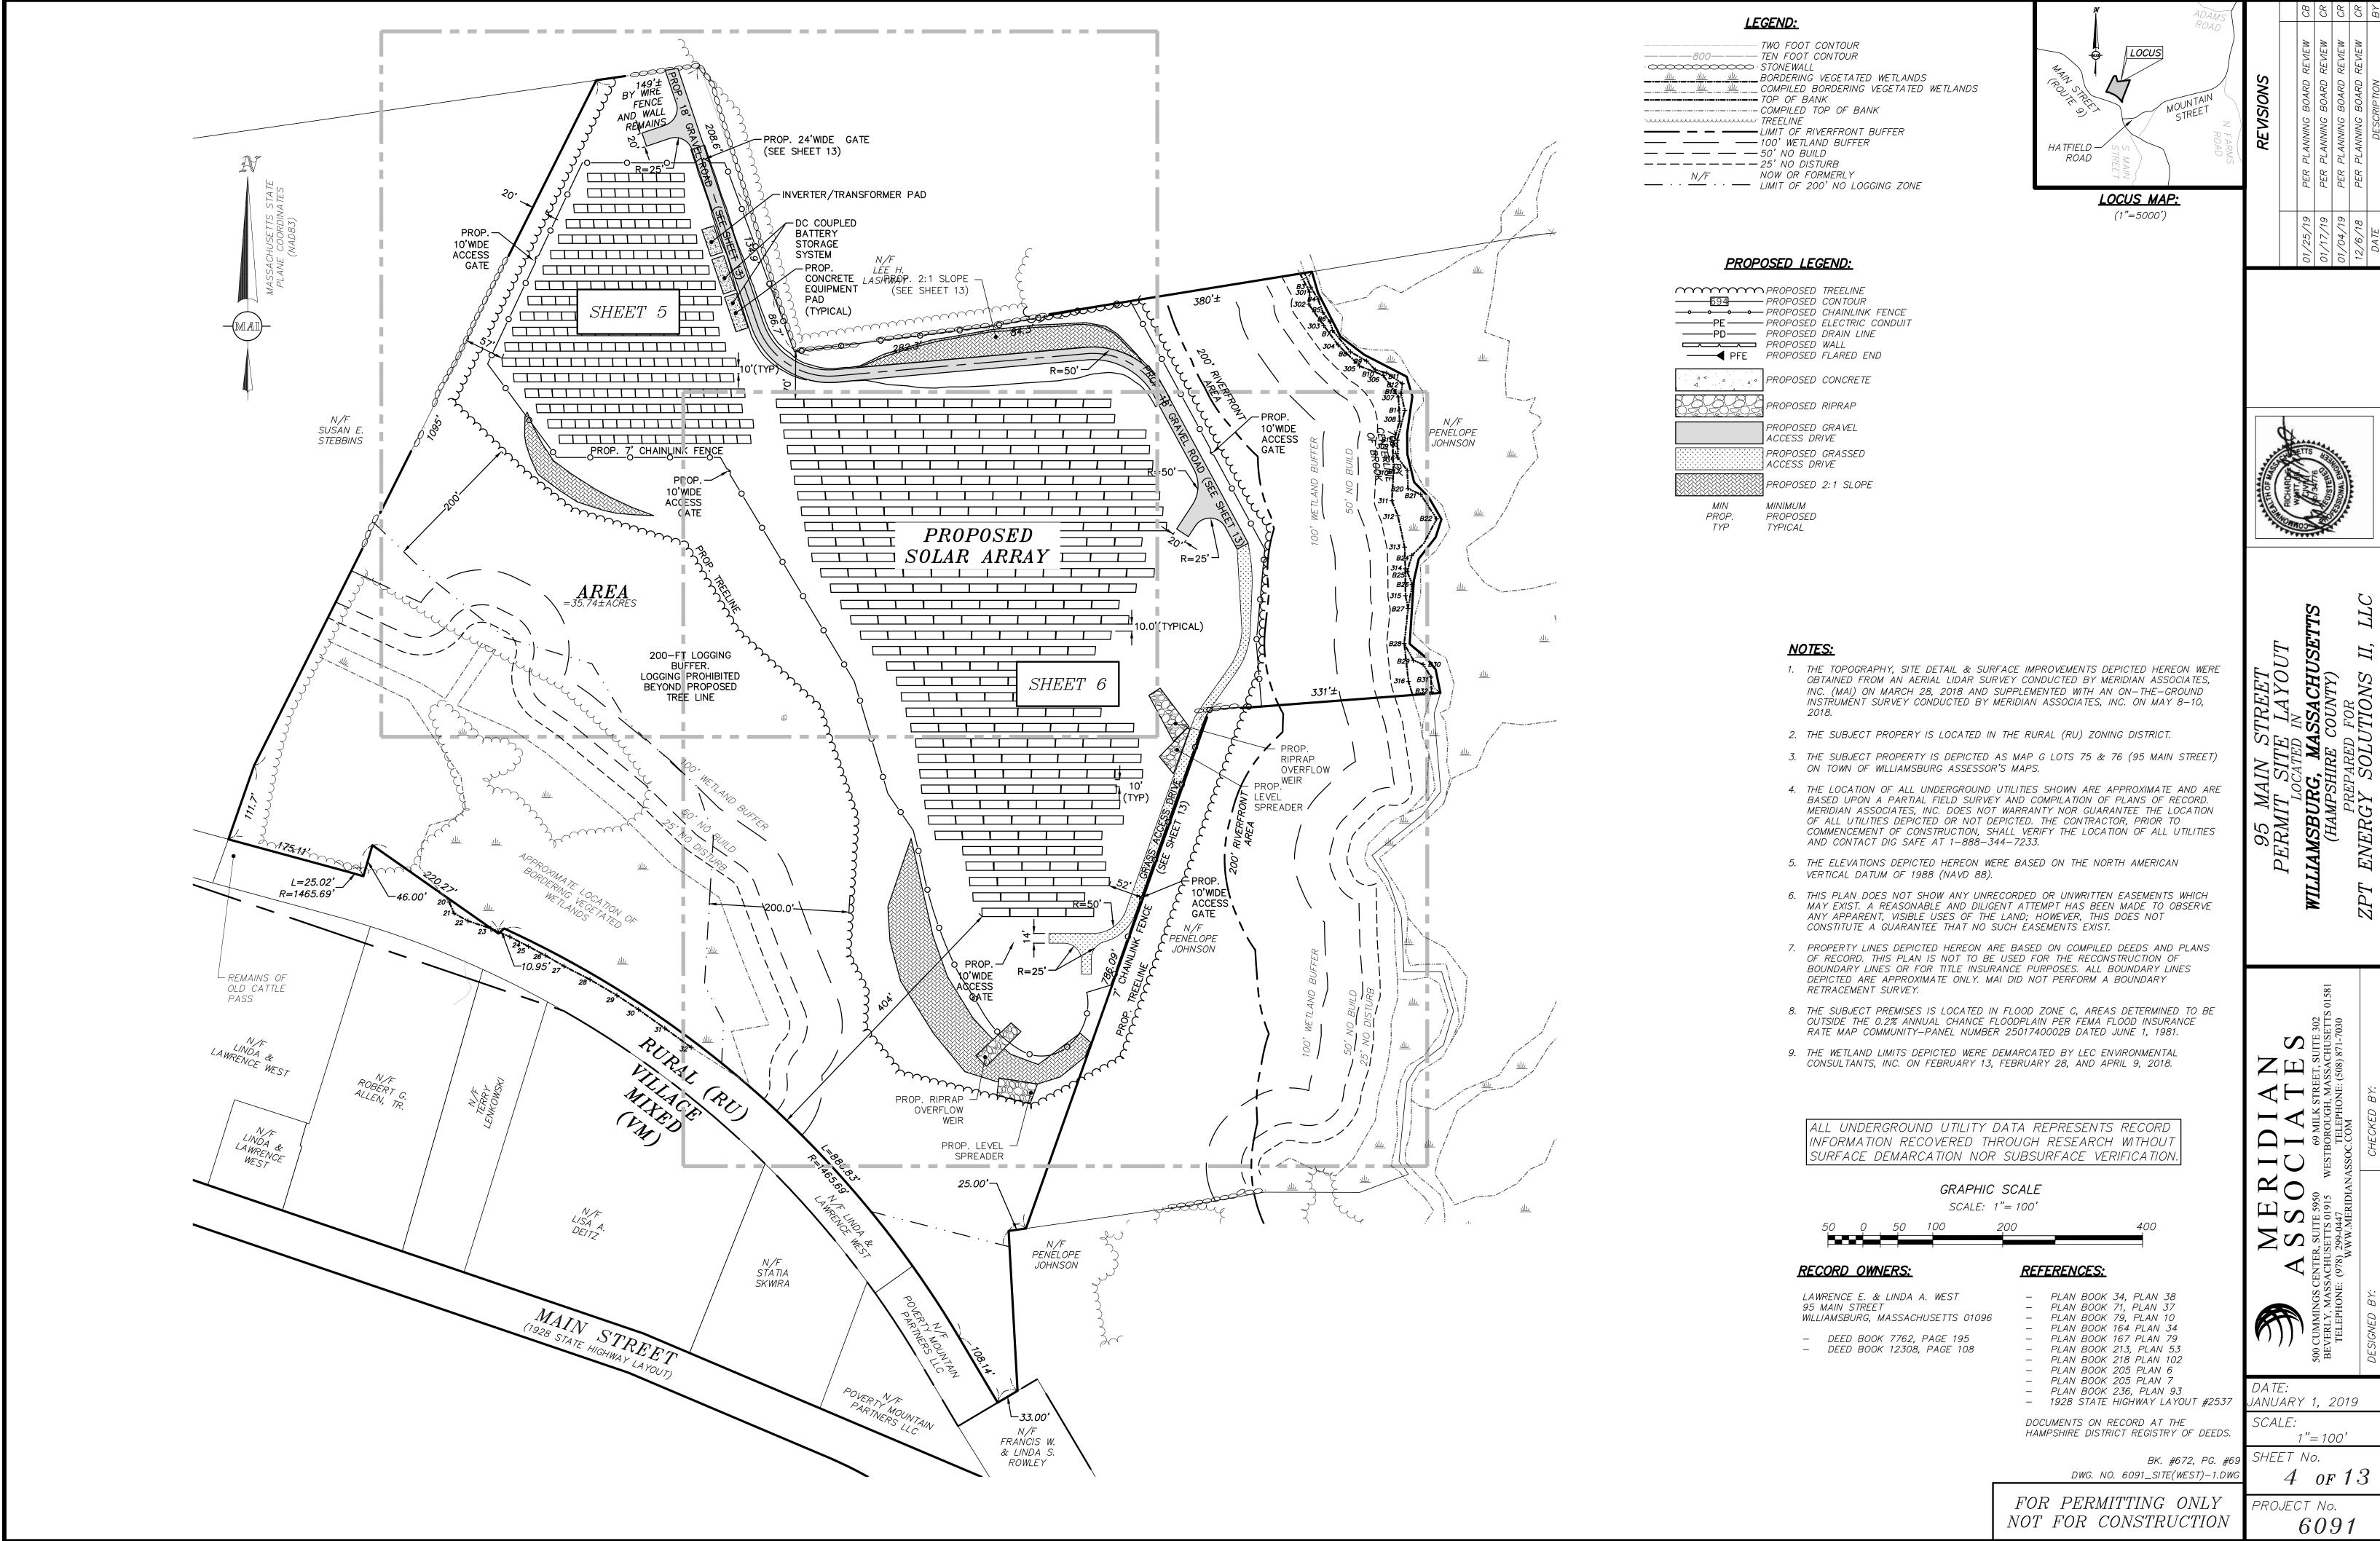


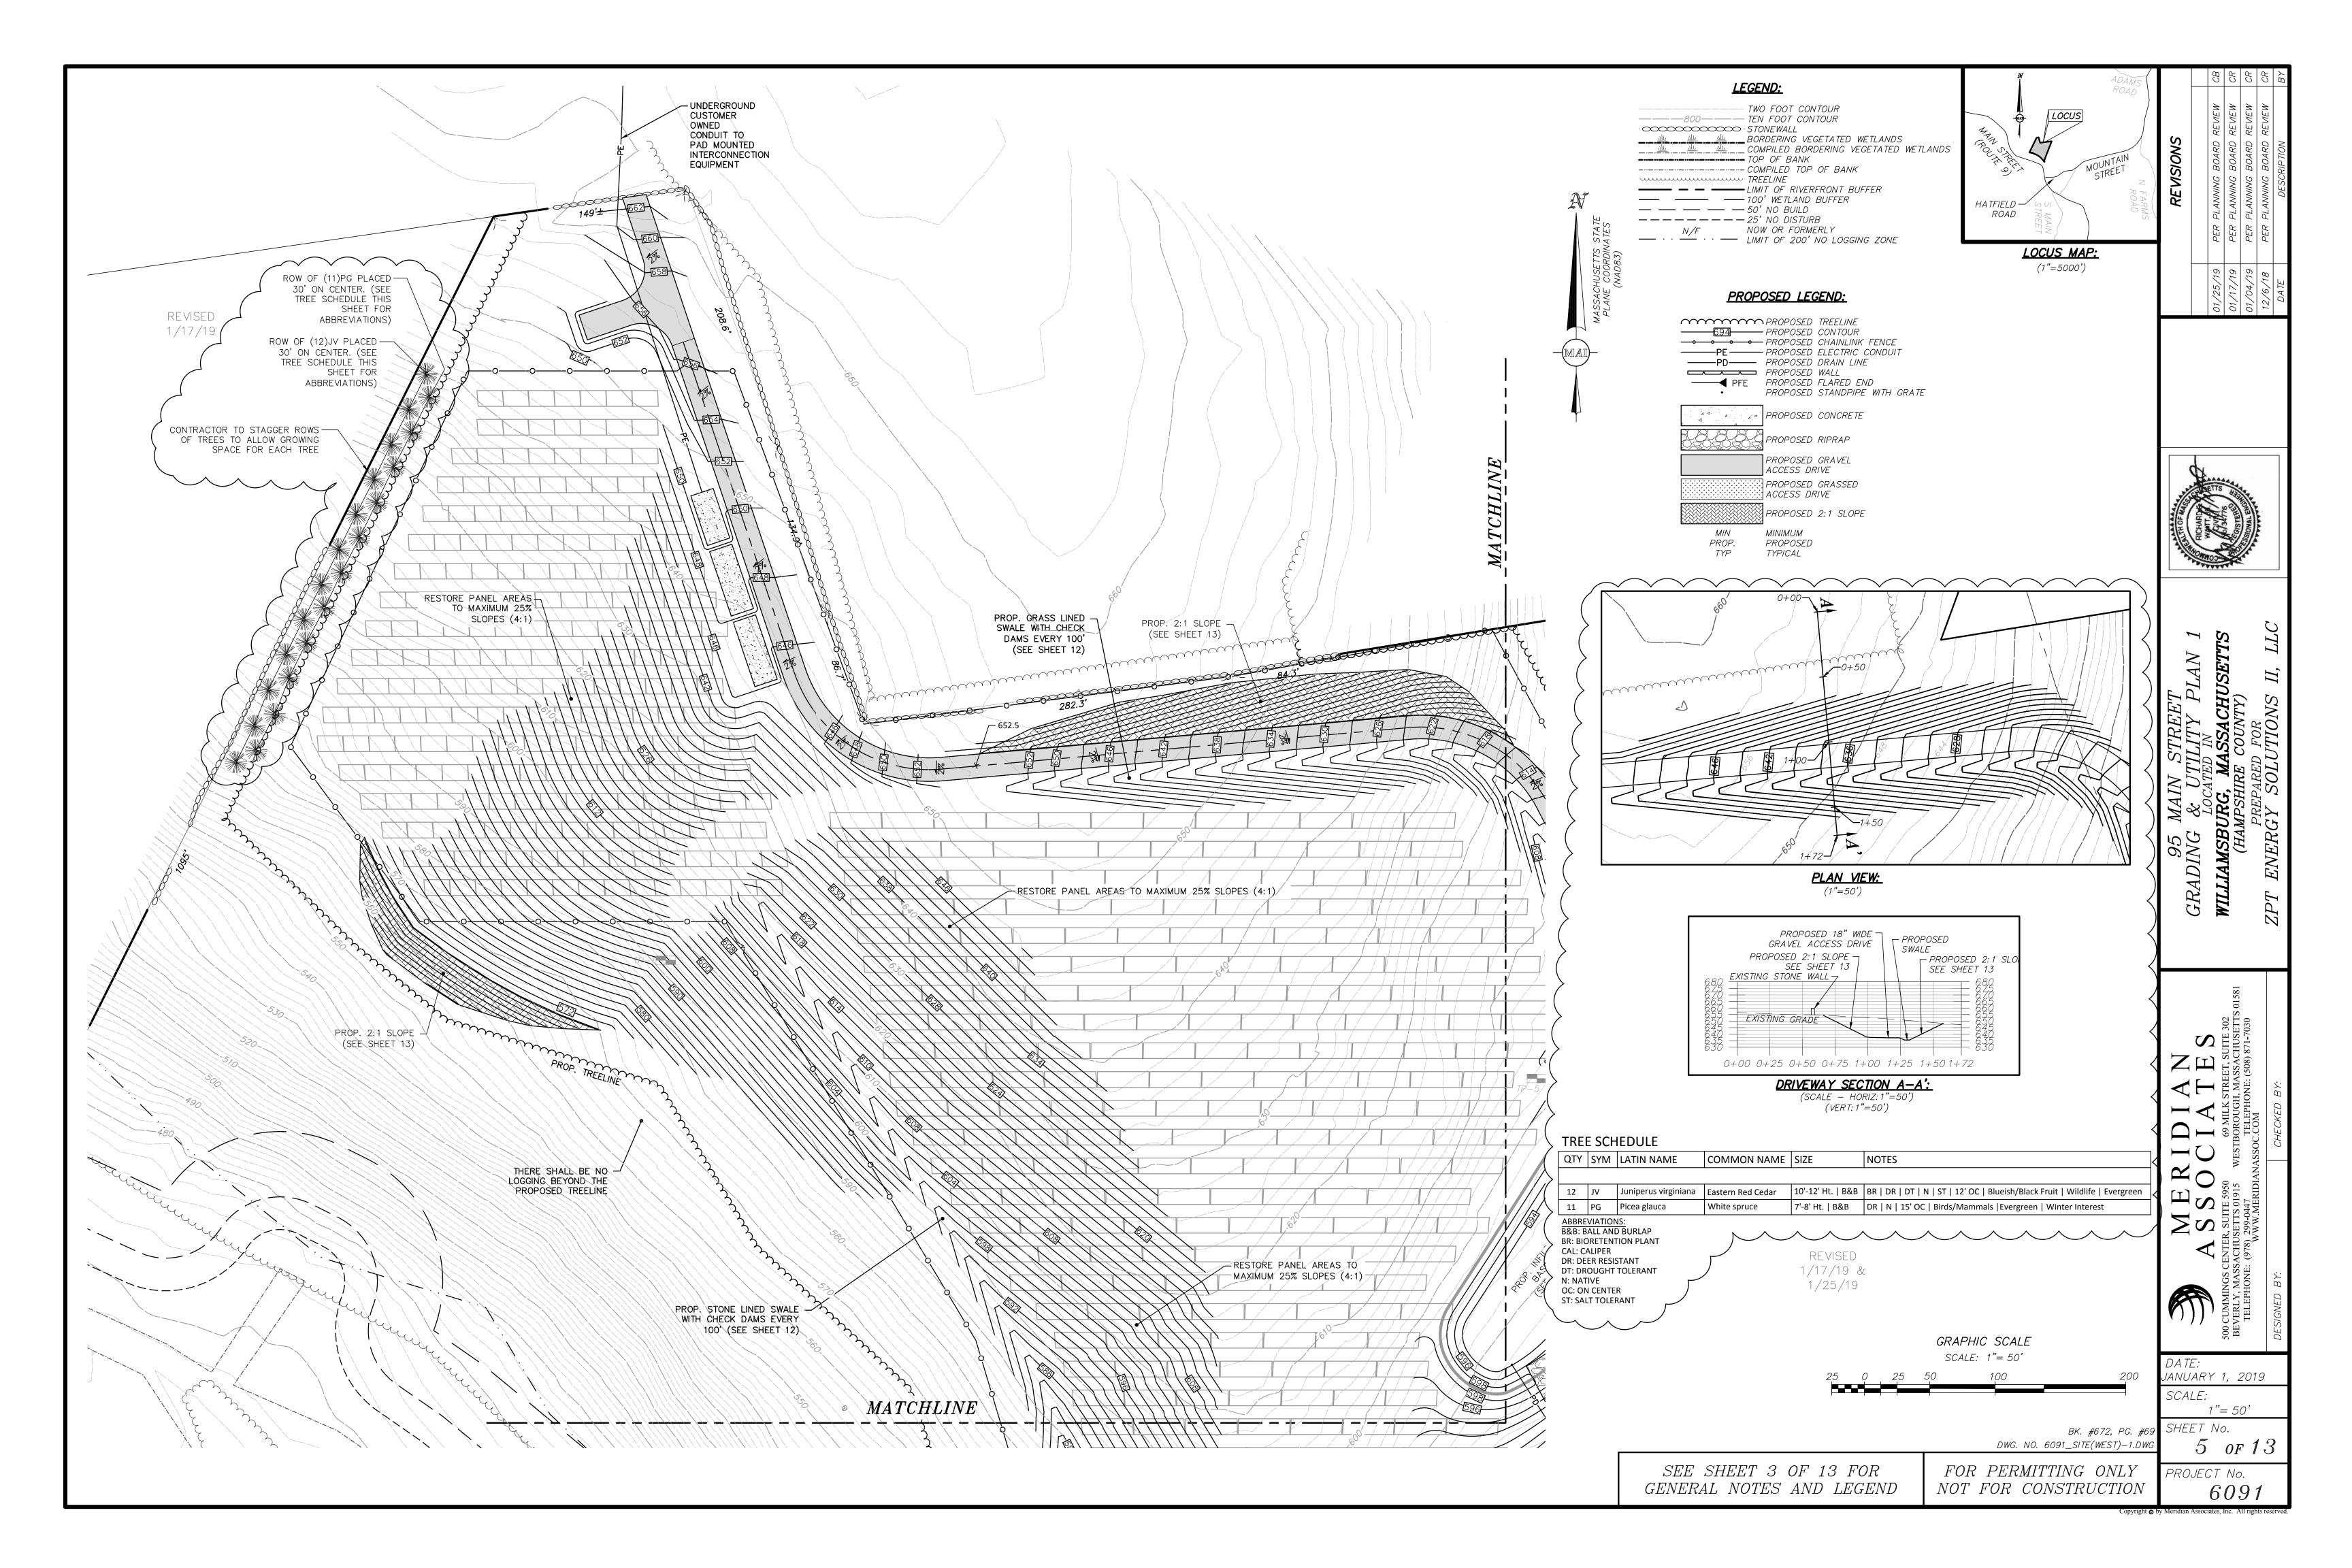


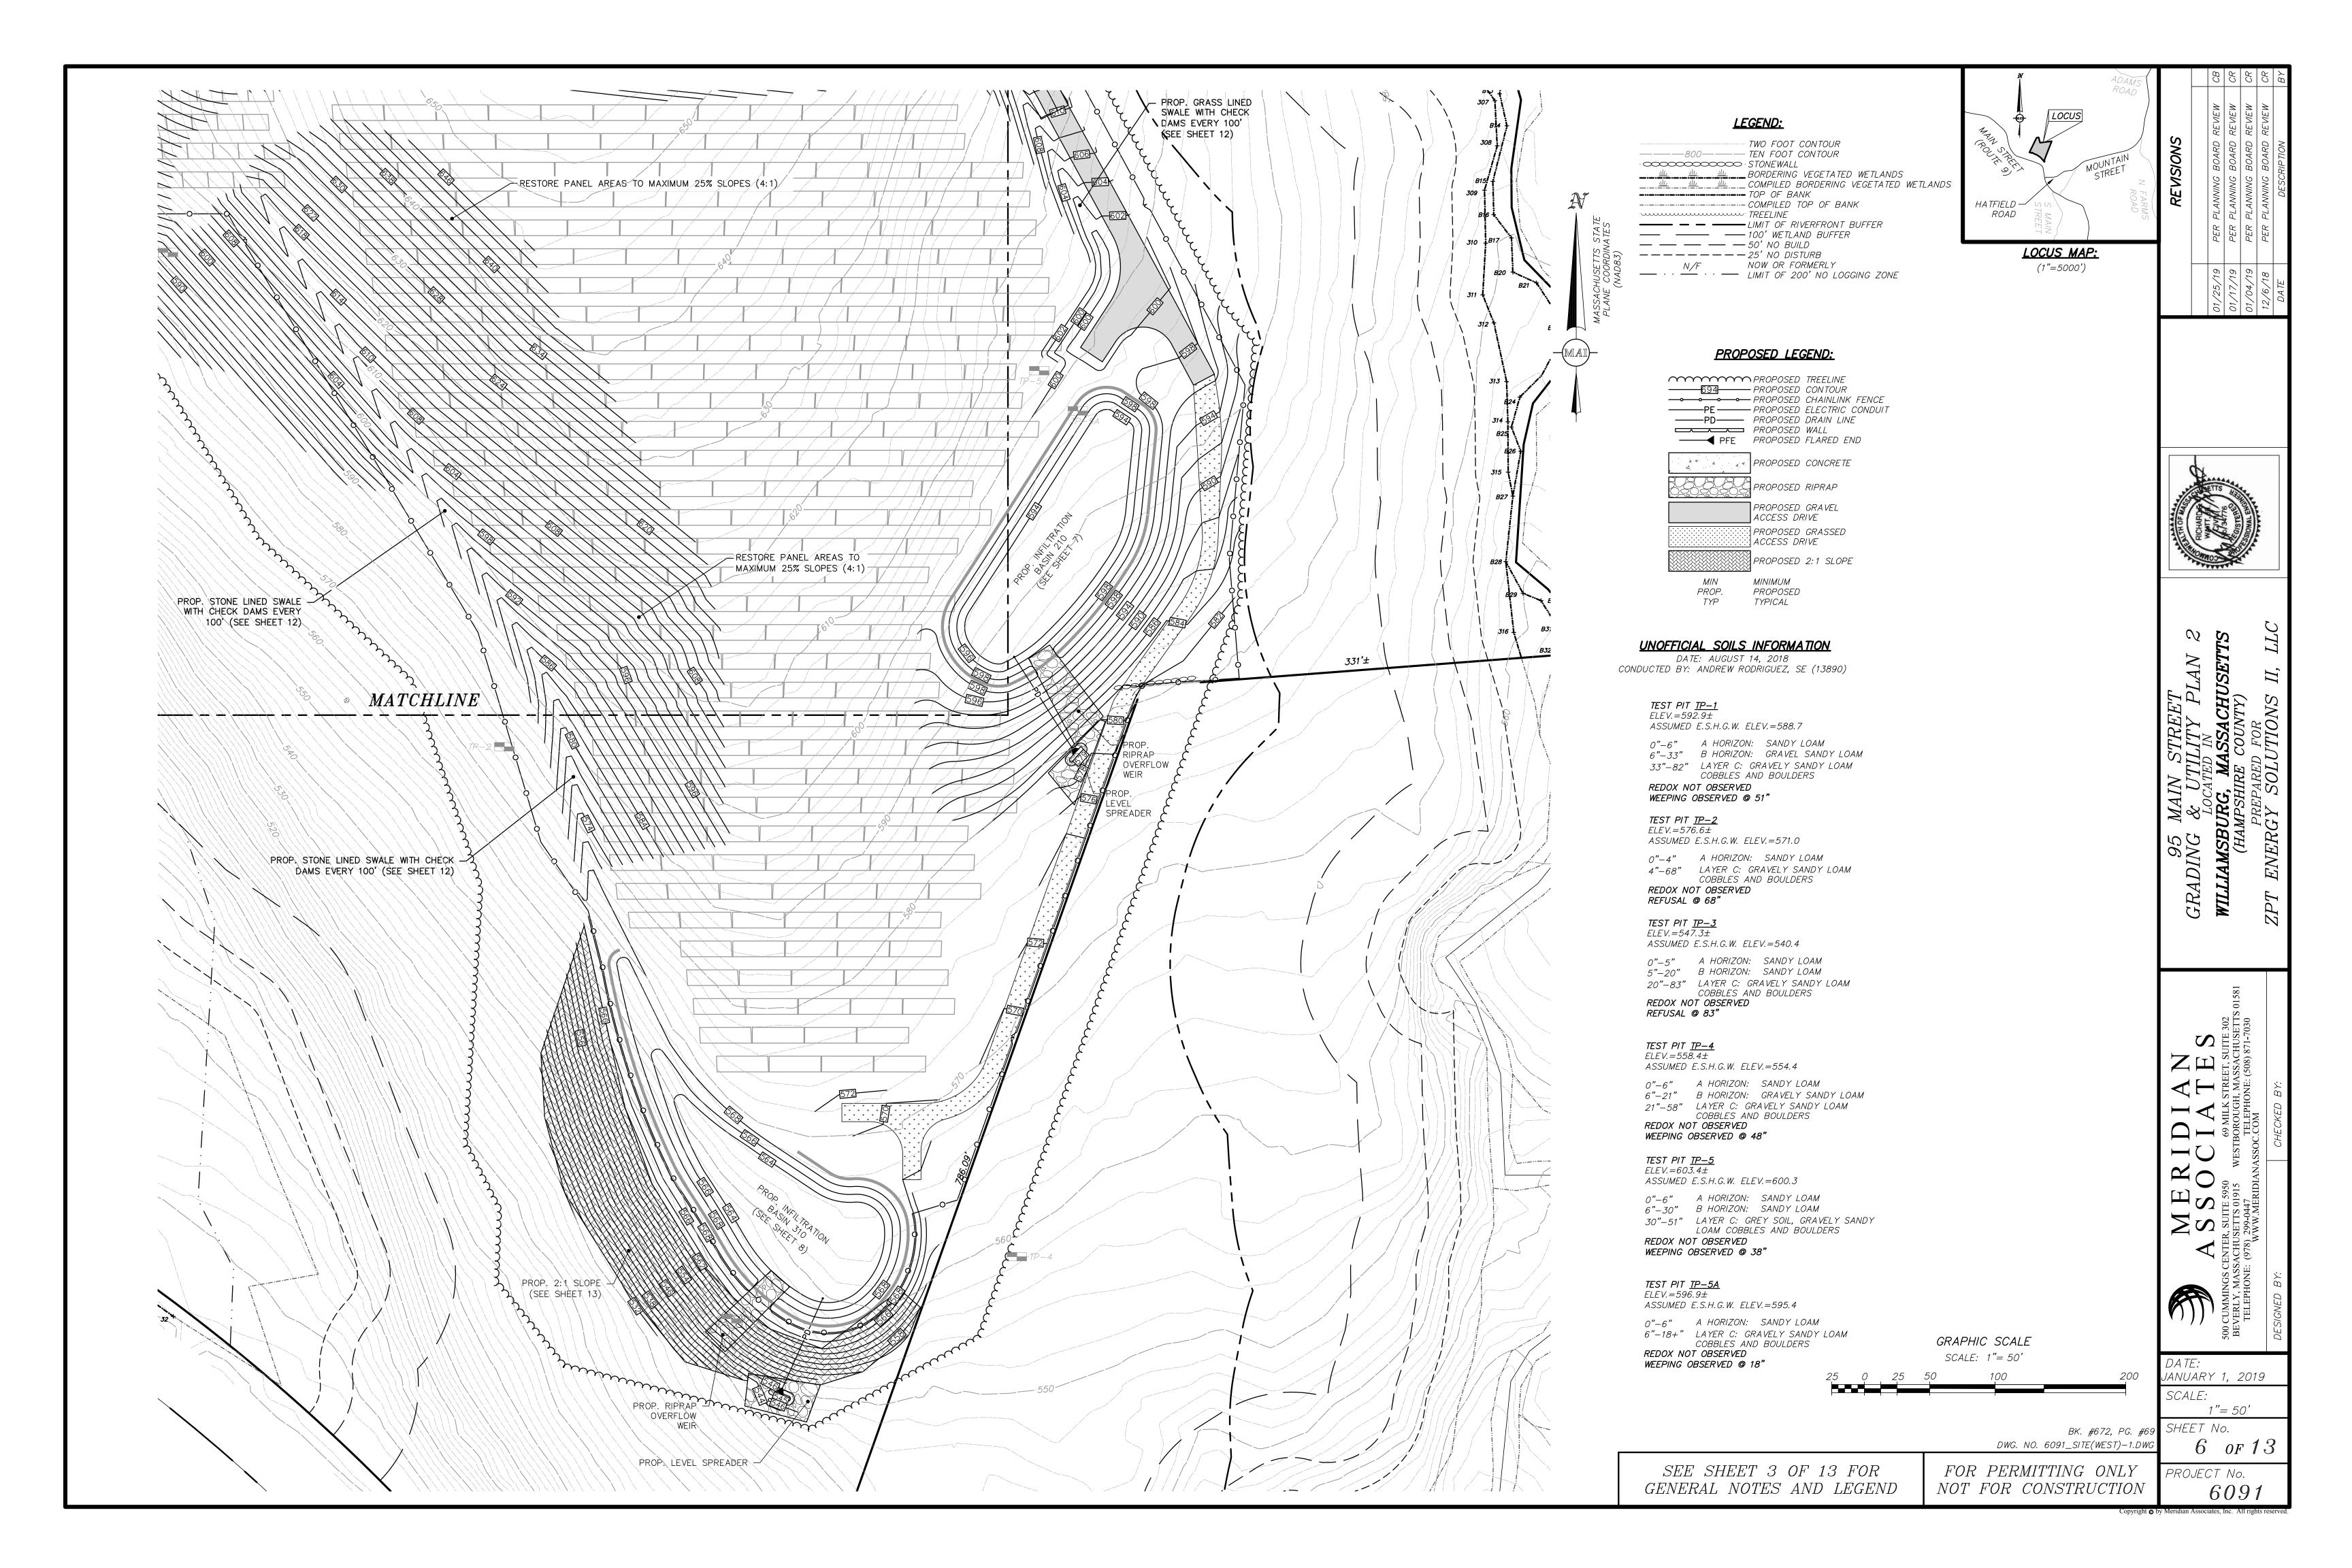

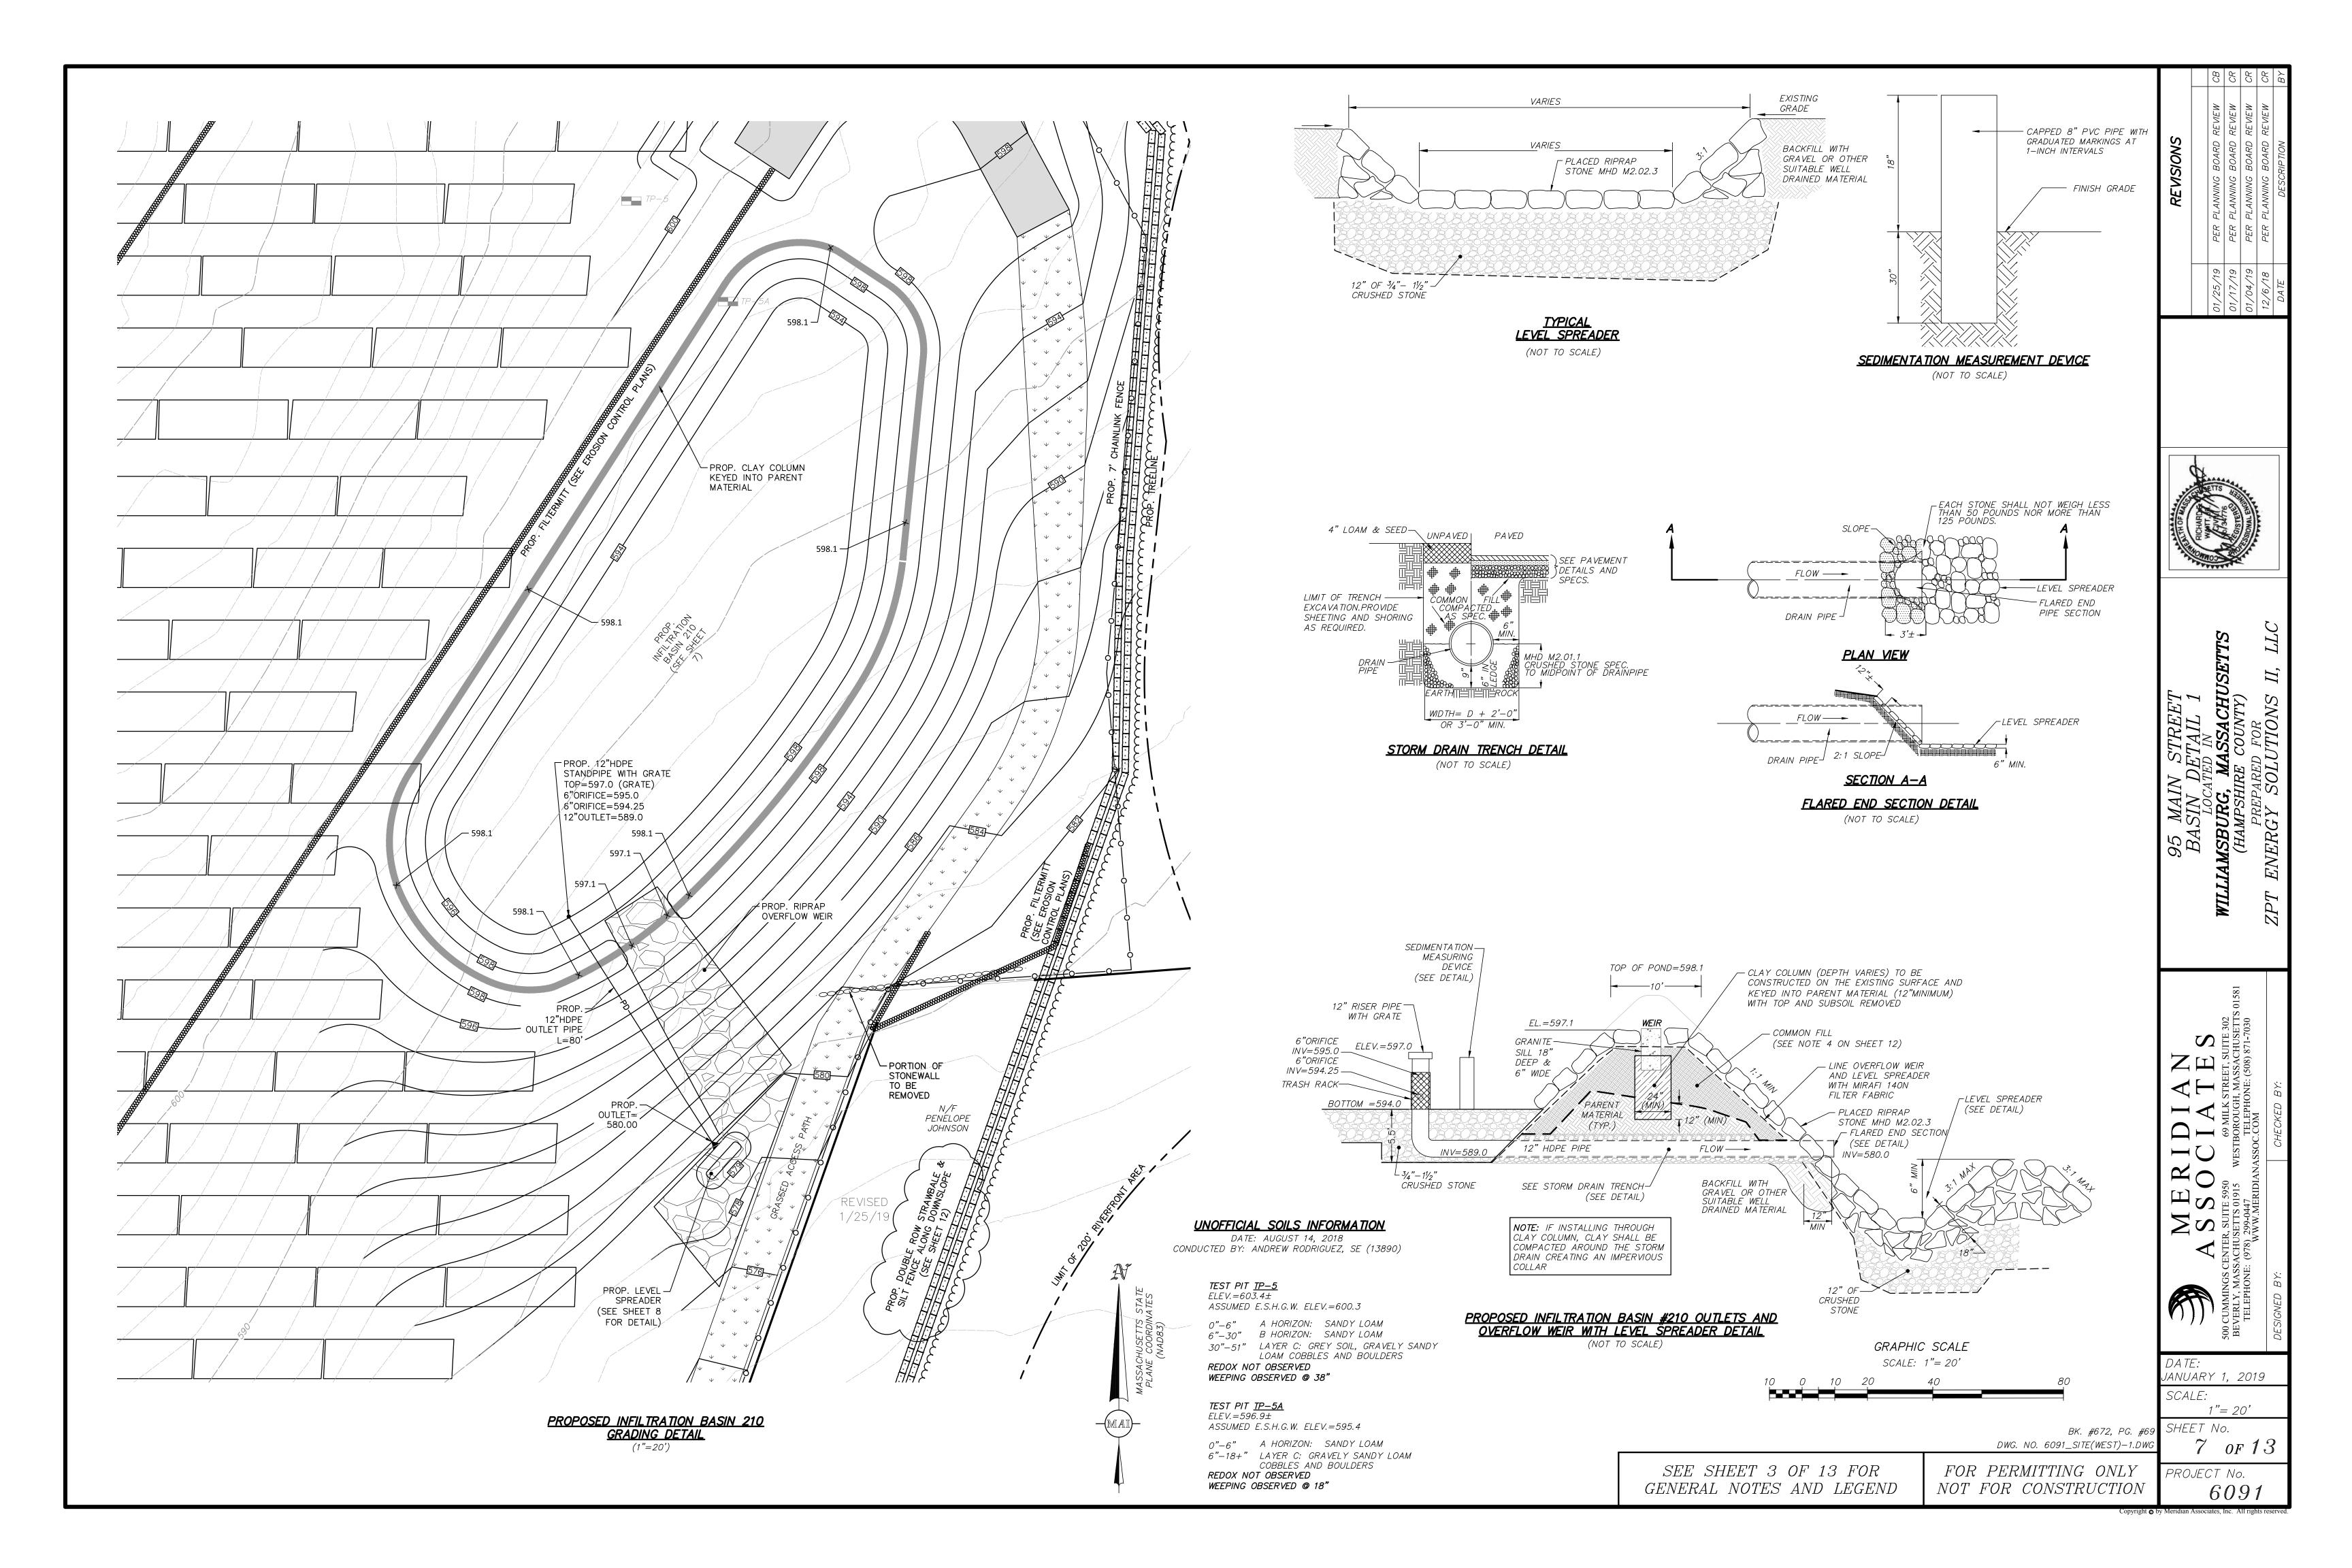

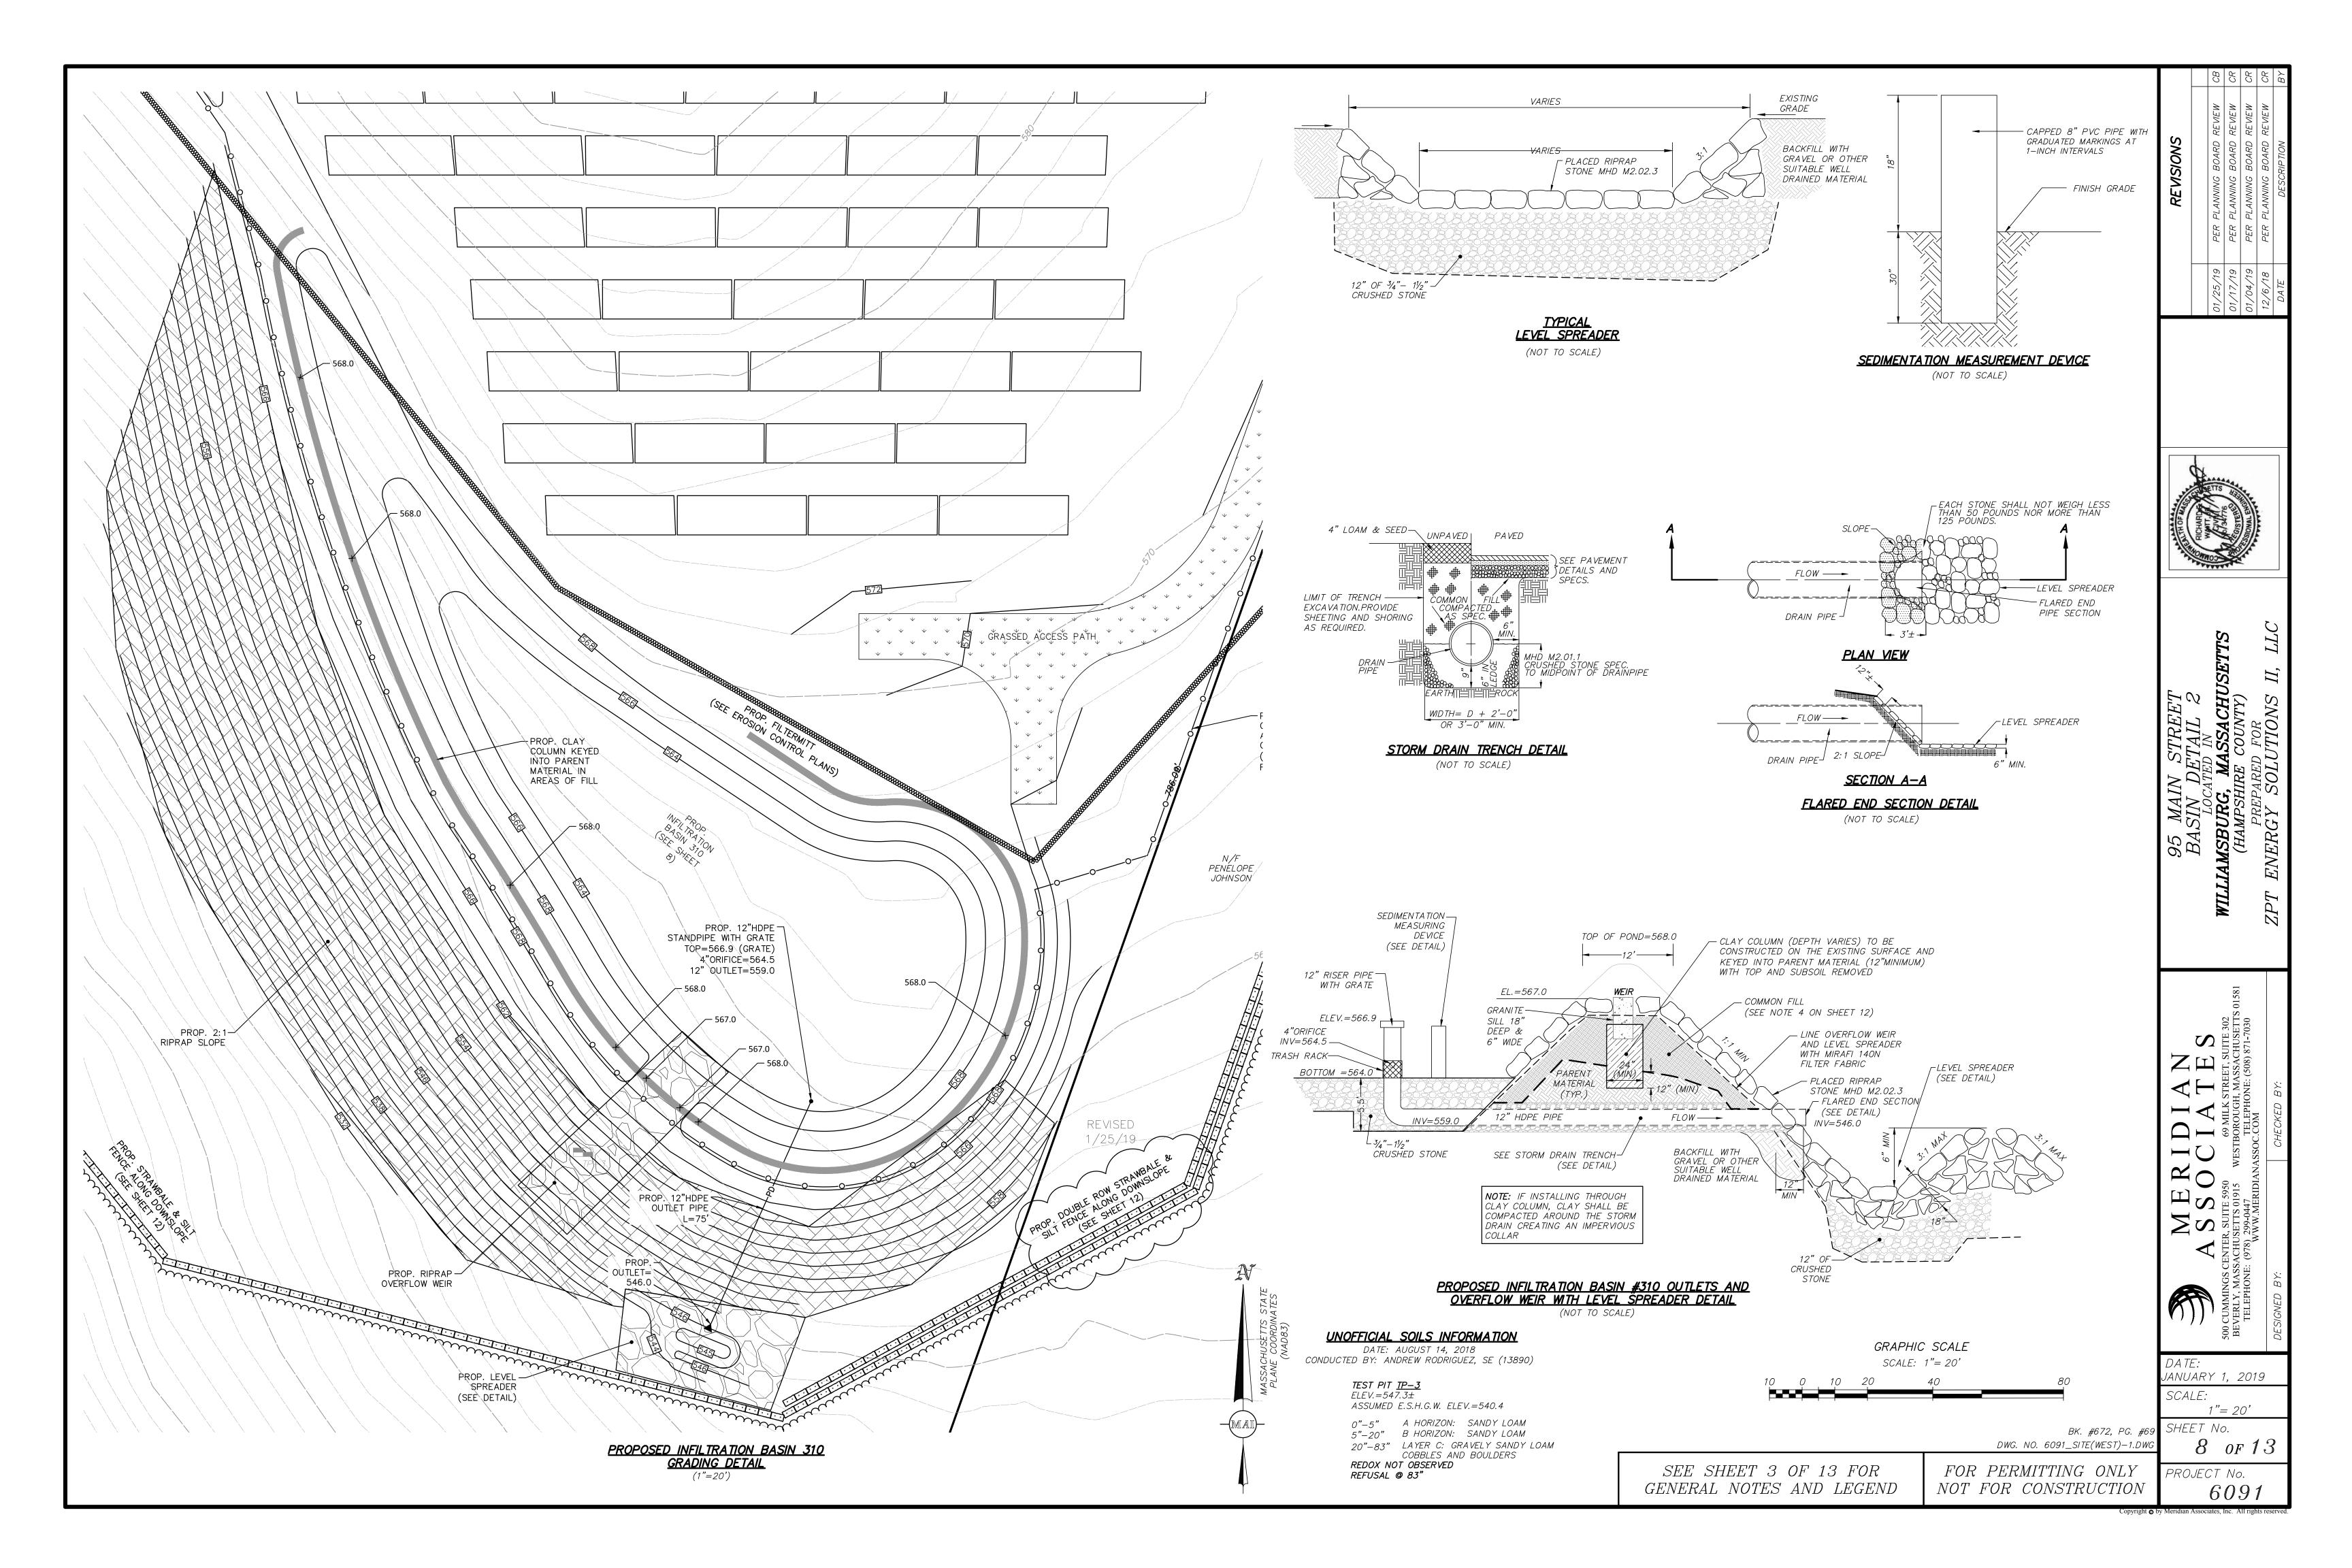

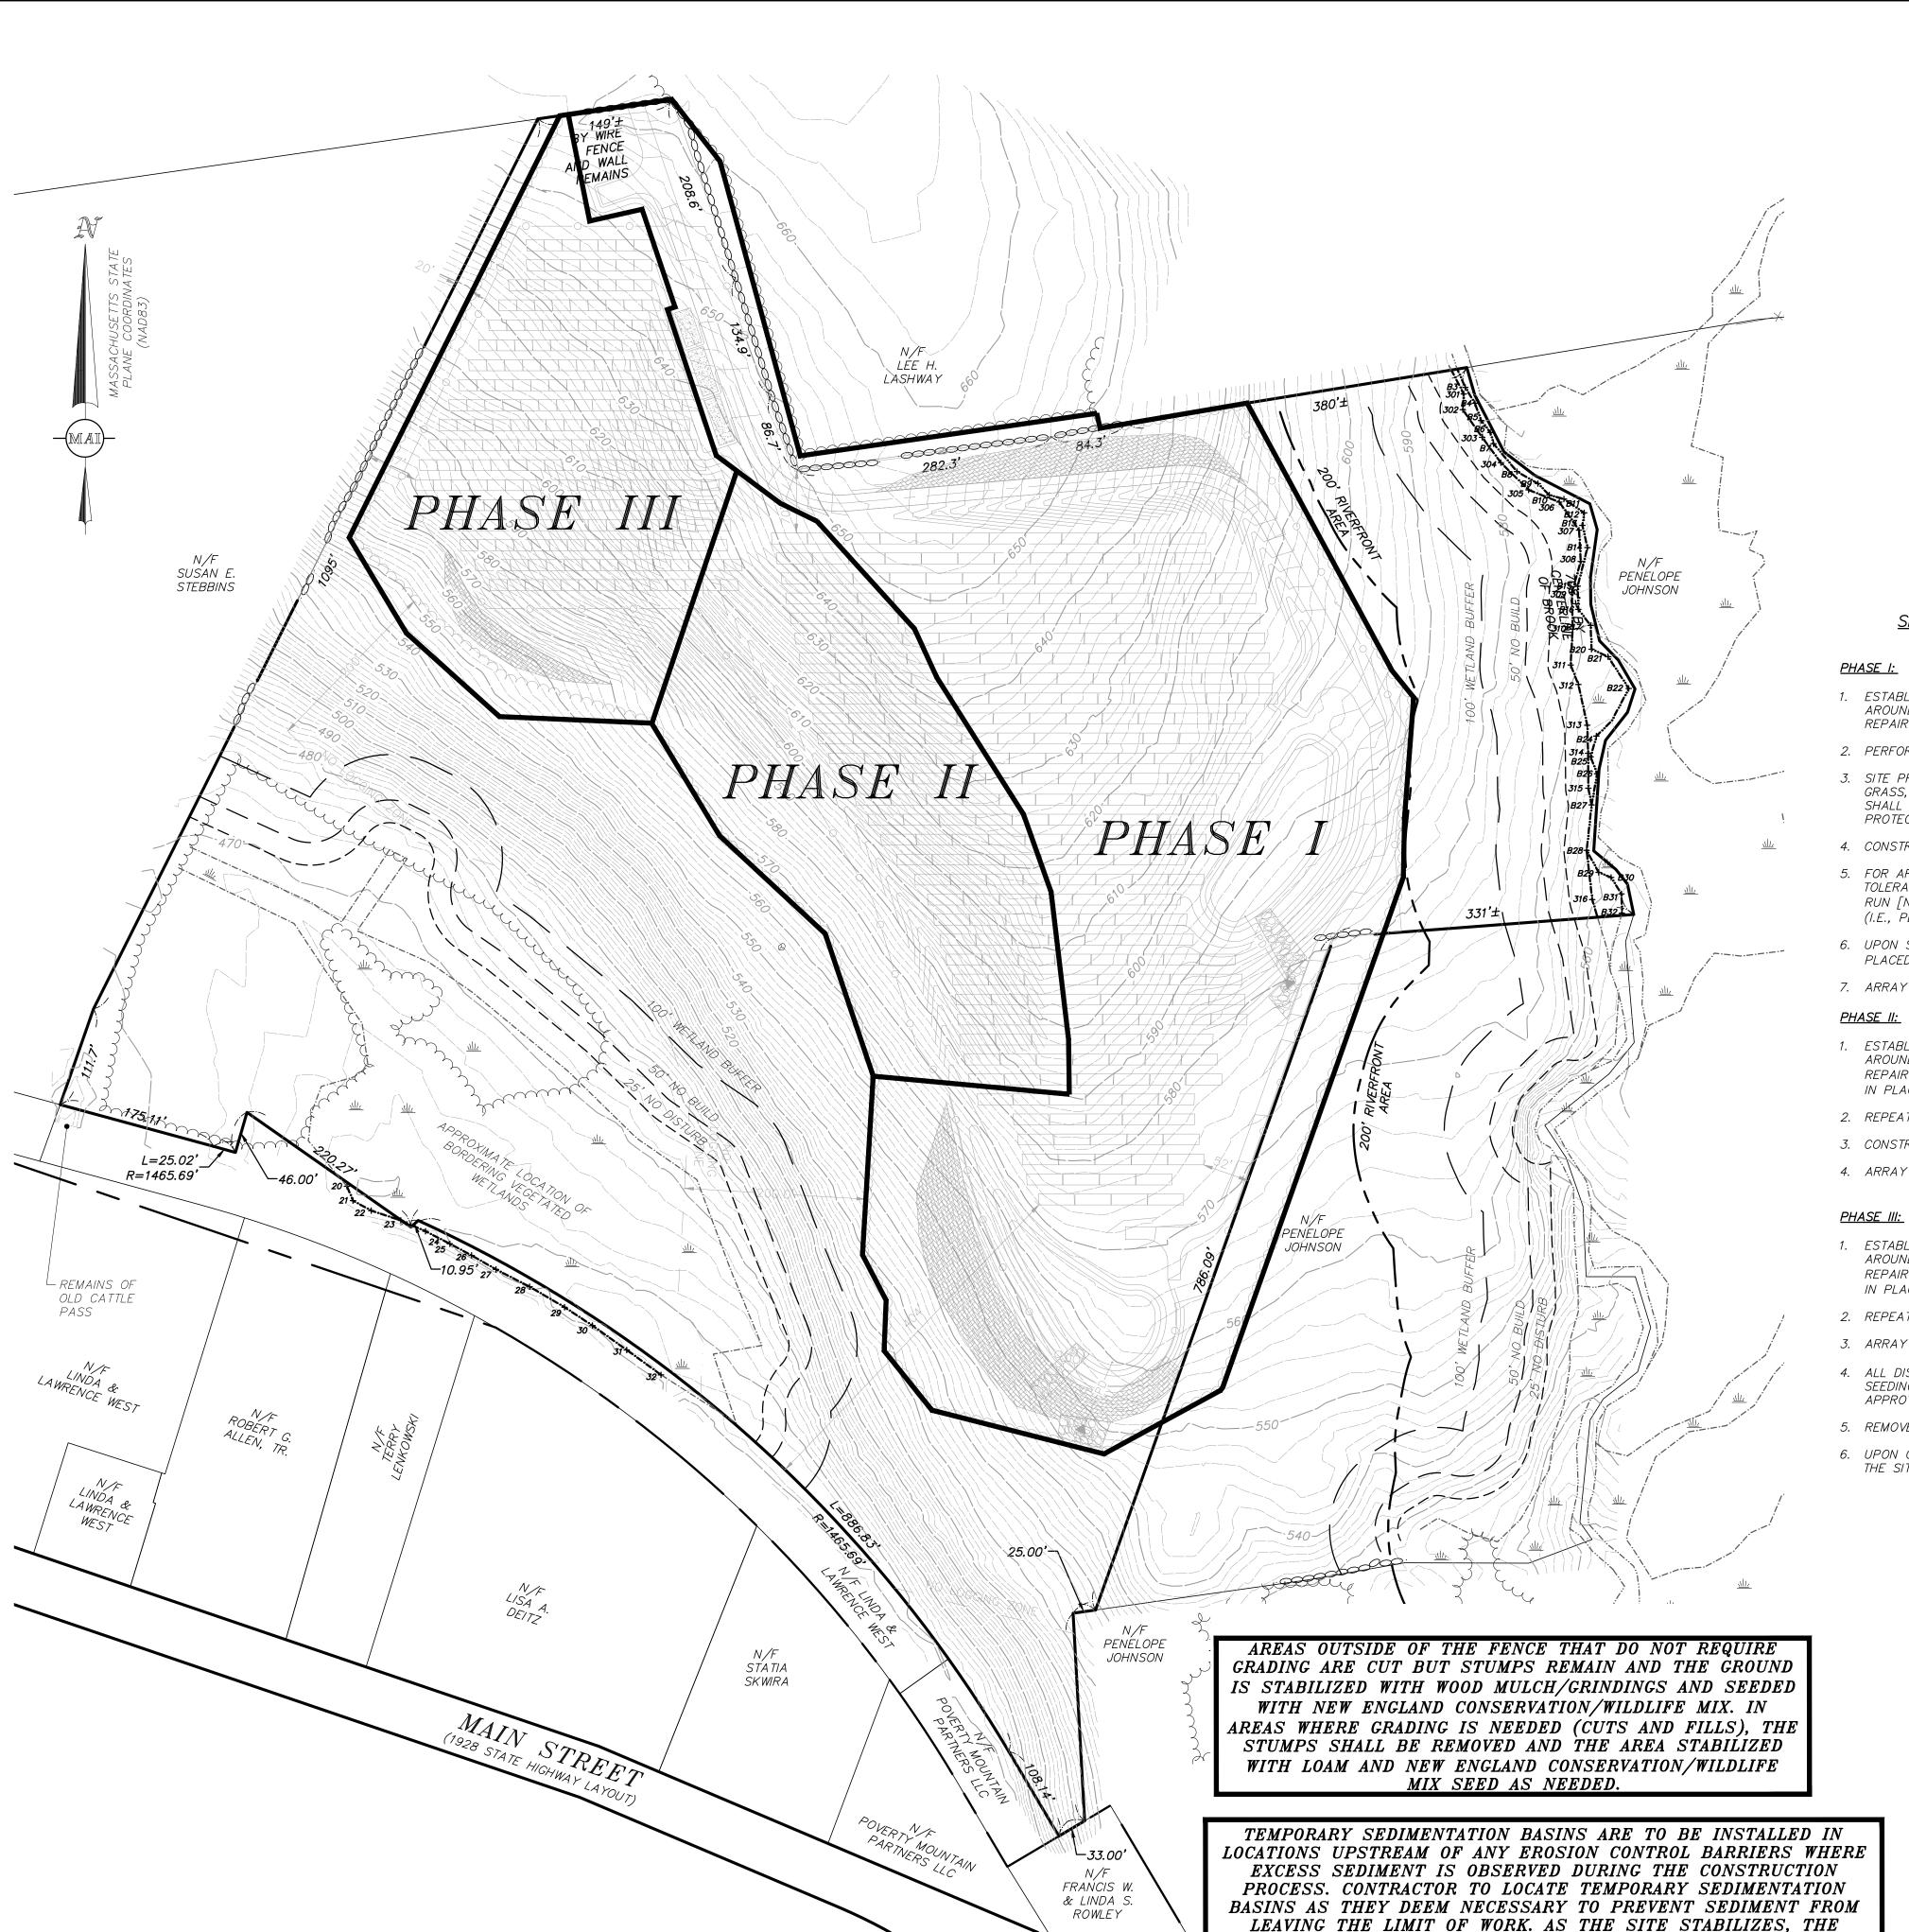

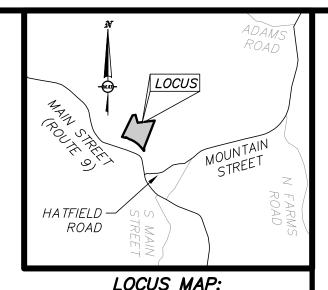

LOCUS MAP: (1"=5000')

NOTES:

- 1. THE PURPOSE OF THIS PLAN IS TO DEPICT THE APPROXIMATE LOCATIONS OF THE PROJECTS CONSTRUCTION PHASES.
- 2. REFER TO SHEETS 10-12 (EROSION CONTROL SHEETS), FOR ADDITIONAL NOTES AND INFORMATION.
- 3. ONCE EROSION CONTROL MEASURES HAVE BEEN ESTABLISHED IN EACH PHASE AND NECESSARY CLEARING AND STABILIZATION HAS BEEN COMPLETED (AS LISTED ABOVE), ARRAY CONSTRUCTION MAY BEGIN. CONTRACTOR SHALL HAVE FLEXIBILITY TO BEGIN ARRAY CONSTRUCTION IN PHASE I, II OR III OUT OF SEQUENCE AS LONG AS IT IS NOT TO THE DETRIMENT OF EROSION AND SEDIMENTATION CONSIDERATION

SITE PREPARATION SHALL BE CONDUCTED IN MULTIPLE PHASES IN ORDER TO MAXIMIZE EROSION AND SEDIMENTATION CONTROL

<u>PHASE I:</u>

- 1. ESTABLISH PHASE 1 EROSION AND SEDIMENTATION CONTROL MEASURES (STRAWBALES, SILT FENCE AND FILTERMITT) AS DEPICTED ON SHEETS 10-11 AROUND AREAS OF DISTURBANCE AND MAINTAIN THROUGHOUT CONSTRUCTION IN ACCORDANCE WITH LOCAL REQUIREMENTS. PERFORM INSPECTIONS, REPAIR IF NECESSARY, AND DOCUMENT AFTER EACH PRECIPITATION EVENT OF 0.25-INCHES OR GREATER.
- 2. PERFORM LIMITED CLEARING ACTIVITIES IN ORDER TO CONSTRUCT GRAVEL ACCESS DRIVE AND GRASSED ACCESS PATH.
- 3. SITE PREPARATION SHALL INCLUDE CLEARING AND REMOVAL OF EXISTING VEGETATION AND DEBRIS. ALL TREES, STUMPS, BRUSH, SHRUBS, ROOTS, GRASS, WEEDS, RUBBISH, BITUMINOUS PAVEMENT, STONES LARGER THAN 2-IN. IN THE LARGEST DIAMETER AND OTHER OBJECTIONABLE MATERIAL SHALL BE REMOVED AND DISPOSED OF FROM AREAS TO BE FILLED AND COMPACTED. AREAS OUTSIDE OF THE LIMITS OF WORK SHALL BE PROTECTED FROM DAMAGE. NO STUMPS, TREES, LIMBS, OR BRUSH SHALL BE BURIED IN ANY FILLS OR EMBANKMENTS.
- 4. CONSTRUCT INFILTRATION BASINS AND SWALE AS SHOWN ON PLANS.
- 5. FOR AREAS WHERE NO GRADING IS PROPOSED, REPAIR UNEVEN AREAS WITHIN LIMITS OF THE SOLAR DEVELOPMENT, AS NECESSARY TO CREATE A TOLERABLE GROUND SURFACE. GENERAL TOLERANCE FOR ALLOWABLE GROUND SLOPE IS TWO FOOT VERTICAL CHANGE OVER A 20 FOOT HORIZONTAL RUN [NOTE THAT THIS REFERS TO THE ALLOWABLE LONGITUDINAL SLOPE (I.E., ALONG THE CONTOUR) AND NOT THE INCLINATION OF THE EXPOSURE (I.E., PERPENDICULAR TO THE CONTOUR)].
- 6. UPON SIGNS OF CONCENTRATED FLOW BY EVIDENCE OF GULLYING OR RILLING IN DISTURBED AREAS, STRAWBALES, OR APPROVED EQUAL, SHALL BE PLACED IN THESE AREAS, SPACED EVERY 50' IN THE UPGRADIENT SLOPE.
- 7. ARRAY CONSTRUCTION AS SHOWN.

PHASE II:

TEMPORARY SEDIMENTATION BASINS CAN BE REMOVED AND

BROUGHT TO FINISHED GRADES.

- 1. ESTABLISH PHASE II EROSION AND SEDIMENTATION CONTROL MEASURES (STRAWBALES, FILTERMITT & SILT FENCE) AS DEPICTED ON THE PLANS AND AROUND AREAS OF DISTURBANCE AND MAINTAIN THROUGHOUT CONSTRUCTION IN ACCORDANCE WITH LOCAL REQUIREMENTS. PERFORM INSPECTIONS, REPAIR IF NECESSARY, AND DOCUMENT AFTER EACH PRECIPITATION EVENT OF 0.25-INCHES OR GREATER (PHASE I EROSION CONTROL IS TO REMAIN IN PLACE AND MAINTAINED AS DESCRIBED ABOVE).
- 2. REPEAT STEPS 2, 3, 5 AND 6 ABOVE FOR PHASE II.
- 3. CONSTRUCT SWALE AS SHOWN ON PLANS.
- 4. ARRAY CONSTRUCTION AS SHOWN.
- 1. ESTABLISH PHASE III EROSION AND SEDIMENTATION CONTROL MEASURES (STRAWBALES, FILTERMITT & SILT FENCE) AS DEPICTED ON THE PLANS AND AROUND AREAS OF DISTURBANCE AND MAINTAIN THROUGHOUT CONSTRUCTION IN ACCORDANCE WITH LOCAL REQUIREMENTS. PERFORM INSPECTIONS, REPAIR IF NECESSARY, AND DOCUMENT AFTER EACH PRECIPITATION EVENT OF 0.25-INCHES OR GREATER (PHASE I EROSION CONTROL IS TO REMAIN IN PLACE AND MAINTAINED AS DESCRIBED ABOVE).
- 2. REPEAT STEPS 2, 3, 5 AND 6 ABOVE FROM PHASE I FOR PHASE III.
- 3. ARRAY CONSTRUCTION AS SHOWN.
- 4. ALL DISTURBED AREAS SHALL BE RE-ESTABLISHED WITH "NEW ENGLAND CONSERVATION/WILDLIFE MIX" (DEPICTED HEREIN). IN THE EVENT THAT THE SEEDING FALLS OUTSIDE OF THE RECOMMENDED SEEDING DATES, DISTURBED AREAS SHALL BE RE-ESTABLISHED USING ALTERNATIVES METHODS AS APPROVED BY THE PROJECT SITE ENGINEER.
- 5. REMOVE ANY ACCUMULATED SEDIMENT FROM TEMPORARY SEDIMENTATION BASINS. BRING TEMPORARY SEDIMENTATION BASINS TO GRADE AND SEED.
- 6. UPON COMPLETION OF CONSTRUCTION ACTIVITIES WITHIN THE LIMIT OF WORK, THE CONTRACTOR SHALL EFFECTIVELY AND PERMANENTLY STABILIZE

GRAPHIC SCALE SCALE: 1"=100'

> BK. #672, PG. #69 DWG. NO. 6091_SITE(WEST)-1.DWG

SEE SHEET 3 OF 13 FOR GENERAL NOTES AND LEGEND


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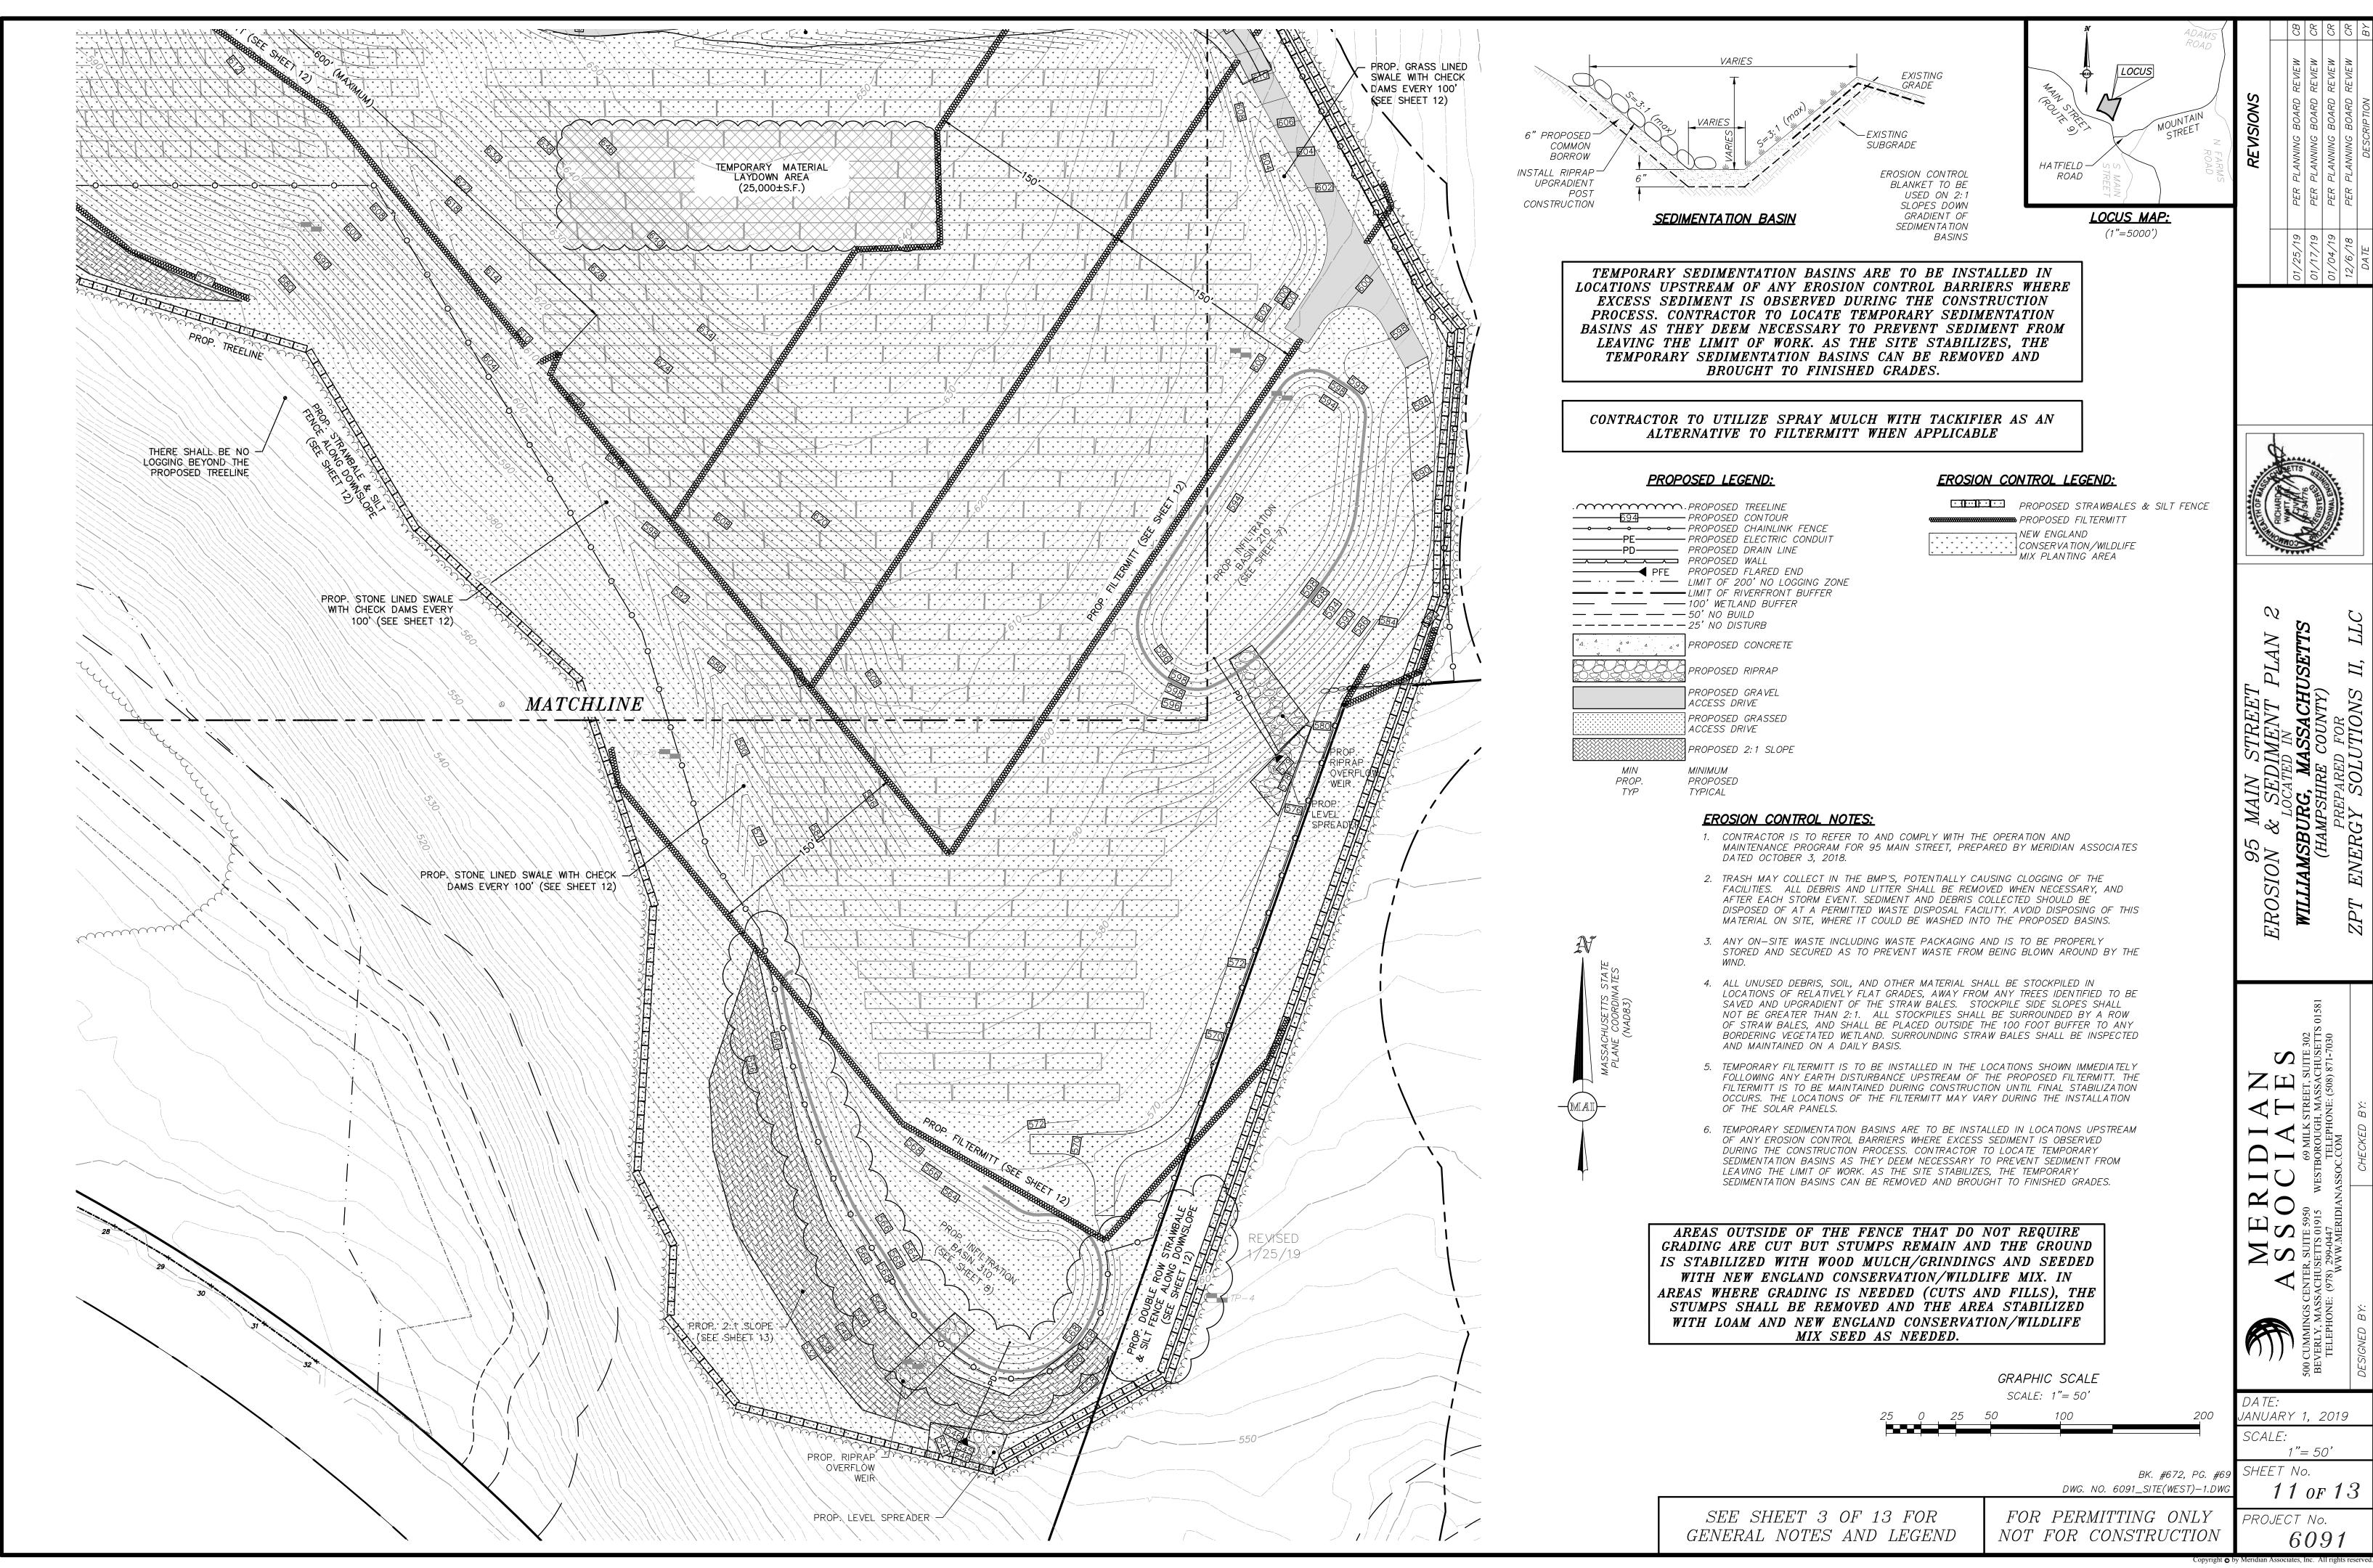
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JANUARY 1, 2019 1" = 100'

SHEET No. 9 of 13

PROJECT No.



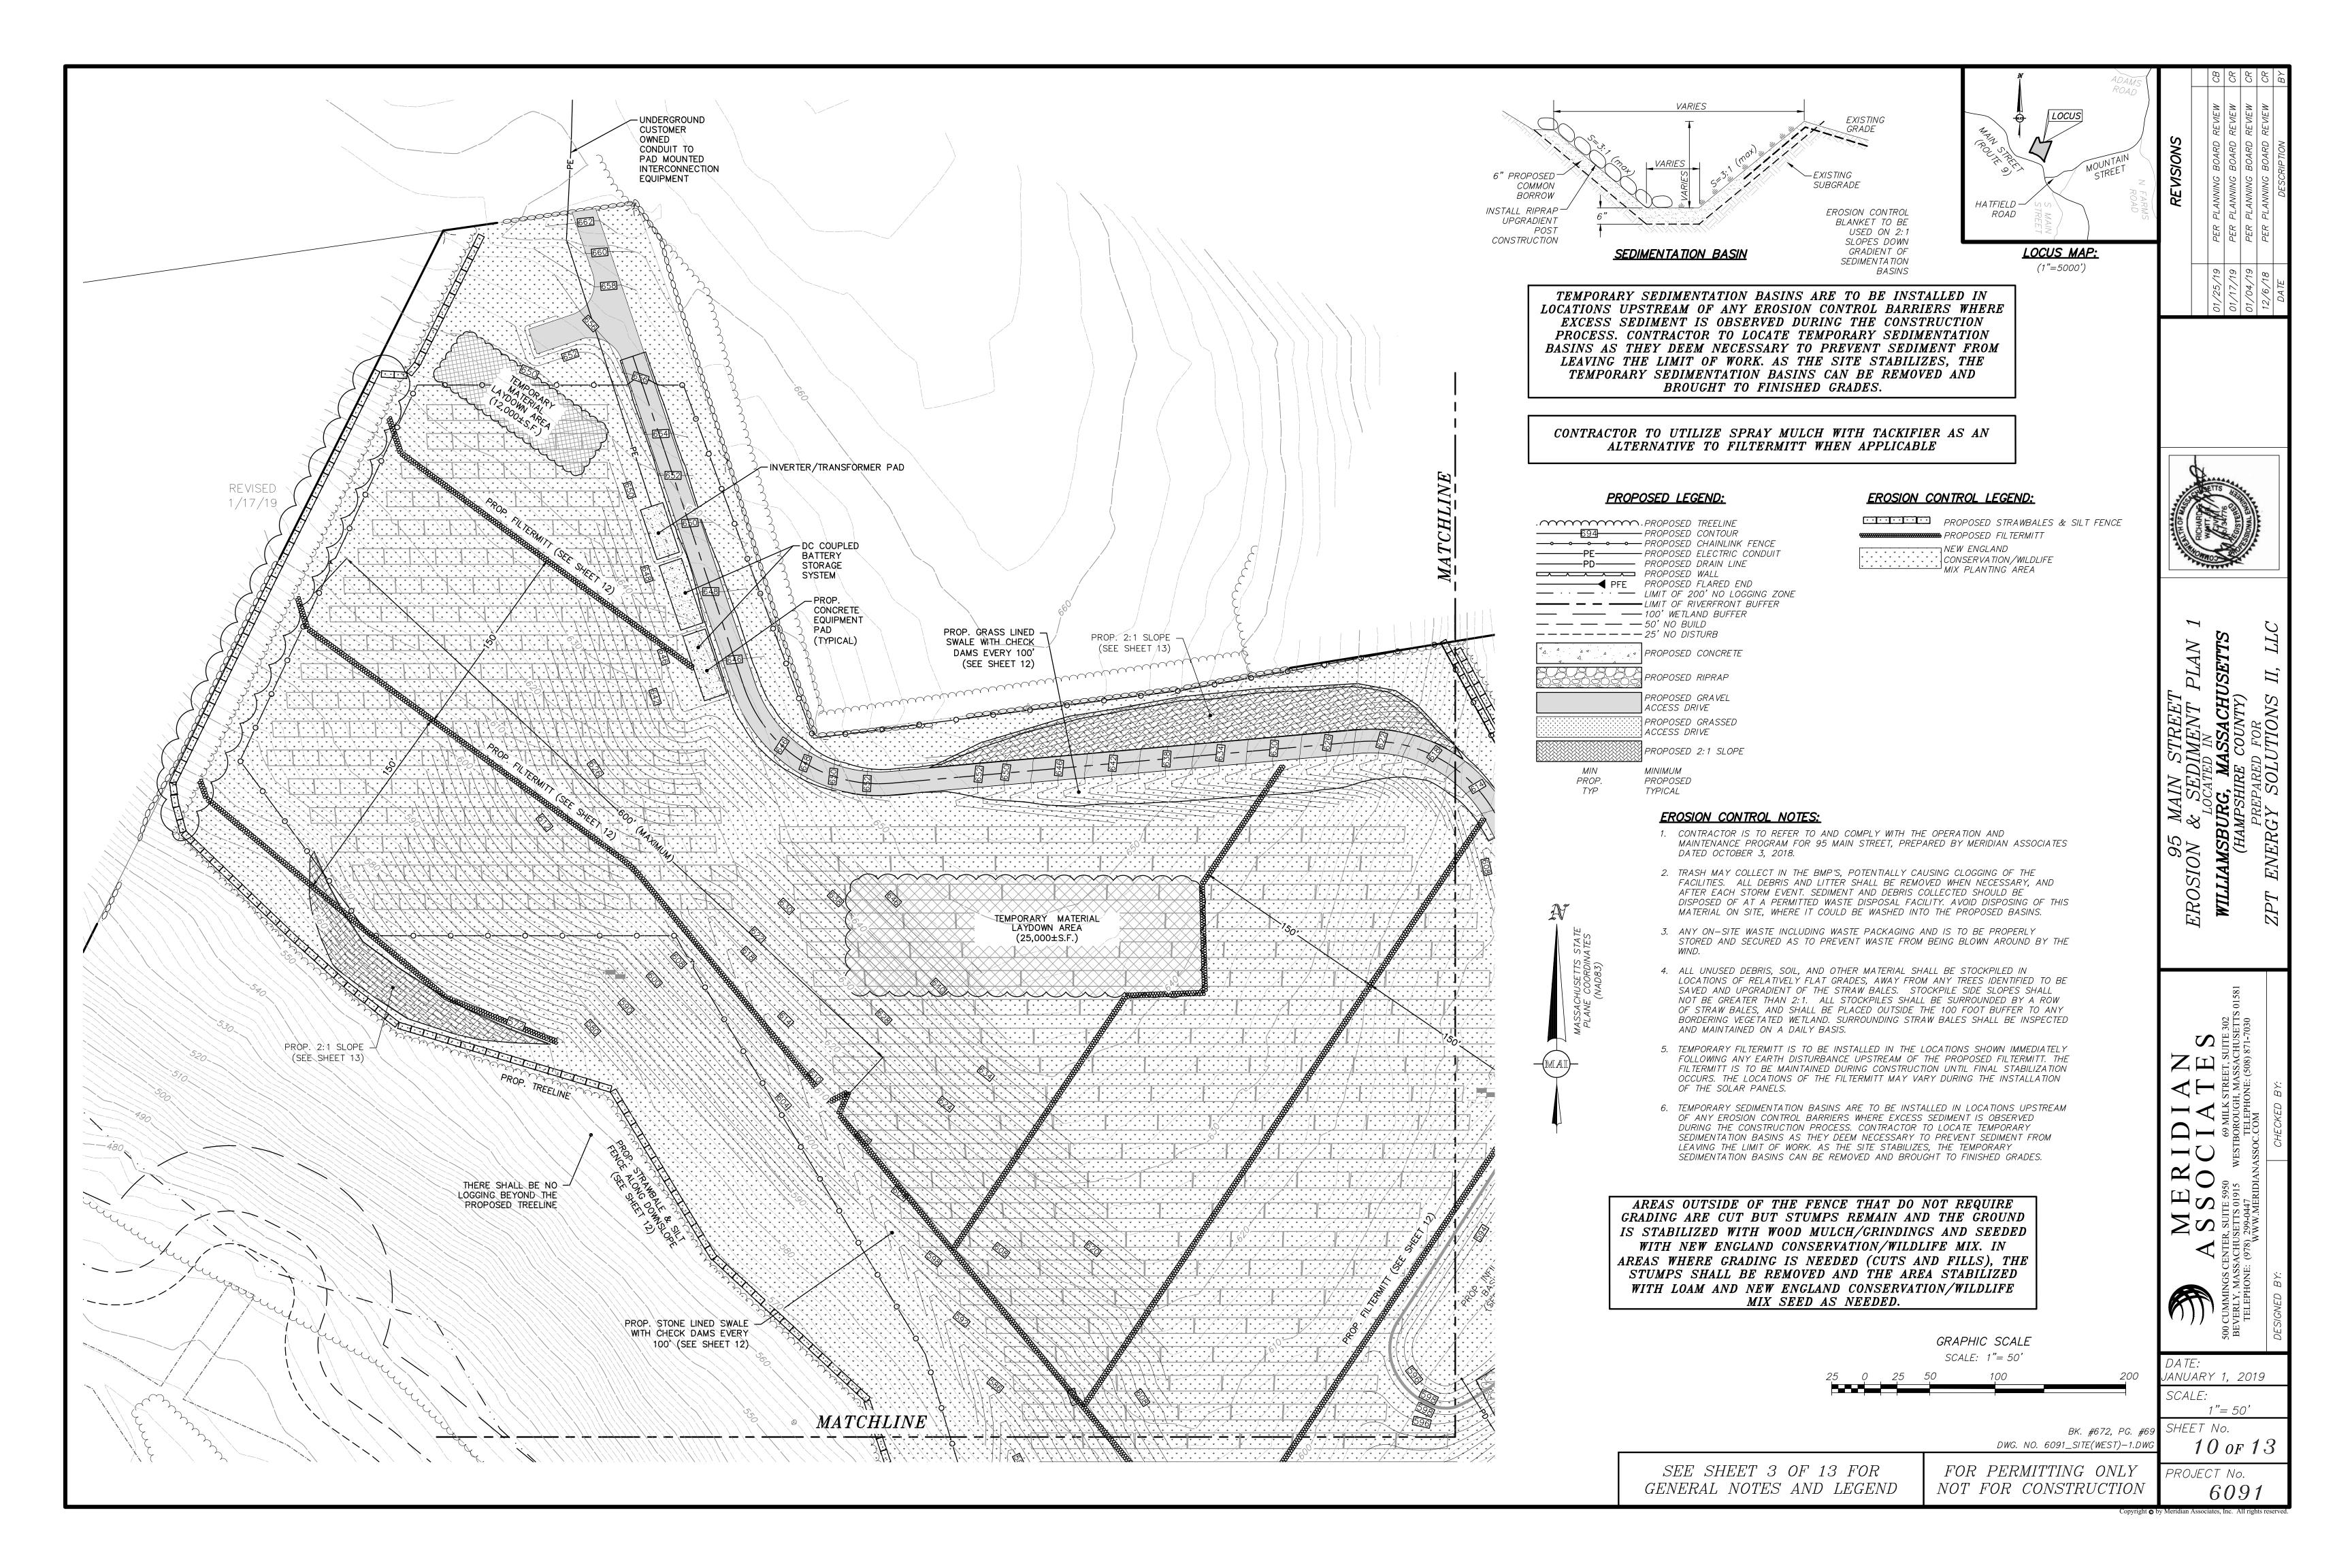

NOTES:

- 1. EXISTING GROUND WITHIN THE PROPOSED CHAINLINK FENCE SHALL BE CLEARED. STUMPED AND RE-GRADED TO ELIMINATE MINOR SURFACE DISTURBANCES. RE-VEGETATION OF THE SITE SHALL BE ESTABLISHED WITH LOW GROWTH GROUND
- 2. THE PROPOSED TREE CLEARING ALSO DEPICTS THE LIMIT OF WORK TO BE PERFORMED ON THE PROJECT SITE. NO TREES OUTSIDE THE DESIGNATED LIMIT OF WORK LINE ARE TO BE REMOVED BY THE CONTRACTOR.
- 3. COMMON FILL (SITE GRADING AREAS) SHALL CONSIST OF MINERAL SOIL SUBSTANTIALLY FREE FROM ORGANIC MATERIALS, LOAM, WOOD TRASH AND OTHER OBJECTIONABLE MATERIALS WHICH MAY BE COMPRESSIBLE OR WHICH CANNOT BE PROPERLY COMPACTED. SELECT COMMON FILL SHALL NOT CONTAIN STONES LARGER THAN 2-IN. IN LARGEST DIAMETER AND SHALL HAVE A MAXIMUM OF 75% PASSING THE NO. 40 SIEVE AND A MAXIMUM OF 20% PASSING THE NO. 200 SIEVE. SELECT COMMON FILL SHALL NOT CONTAIN GRANITE BLOCKS, BROKEN CONCRETE, MASONRY RUBBLE OR OTHER SIMILAR MATERIALS. IT SHALL HAVE PHYSICAL PROPERTIES SUCH THAT IT CAN BE READILY SPREAD AND COMPACTED DURING FILLING. SNOW, ICE AND FROZEN SOIL WILL NOT BE PERMITTED. SOIL EXCAVATED FROM THE STRUCTURE AREAS AND WHICH MEETS THE ABOVE REQUIREMENTS MAY BE USED.
- 4. ORDINARY FILL SHALL BE WELL GRADED, NATURAL INORGANIC SOIL, FREE OF ORGANIC OR OTHER WEAK OR COMPRESSIBLE MATERIALS, FROZEN MATERIALS, AND OF STONES LARGER THAN TWO THIRDS (3/3) THE LIFT THICKNESS. IT SHALL BE OF SUCH NATURE AND CHARACTER THAT IT CAN BE COMPACTED TO THE SPECIFIED DENSITIES IN A REASONABLE LENGTH OF TIME. IT SHALL BE FREE OF PLASTIC CLAY, SPOIL FROM -OF ALL MATERIALS SUBJECT TO DECAY, DECOMPOSITION, OR DISSOLUTION, AND OF CINDERS OR OTHER MATERIALS THAT WILL CORRODE PIPING OR OTHER METAL. IT SHALL HAVE A MINIMUM DRY DENSITY OF NOT LESS THAN 120 POUNDS PER CUBIC FOOT. MATERIAL FROM EXCAVATION ON THE SITE MAY BE USED AS ORDINARY FILL IF IT MEETS THE ABOVE REQUIREMENTS. ORDINARY FILL SHALL HAVE A MAXIMUM OF 60% PASSING THE #40 SIEVE, AND A MAXIMUM OF 20% PASSING THE #200 SIEVE. IT SHOULD NOT CONTAIN BROKEN CONCRETE. MASONRY RUBBLE OR OTHER SIMILAR MATERIALS, AND SHALL HAVE PHYSICAL PROPERTIES SUCH THAT IT CAN BE READILY SPREAD AND COMPACTED DURING FILLING. SNOW, ICE AND FROZEN SOIL SHALL NOT BE PERMITTED.
- 5. SELECT COMMON FILL (ROADWAY AREAS) SHALL BE PLACED IN LAYERS HAVING A MAXIMUM THICKNESS OF 8 IN. MEASURED BEFORE COMPACTION. EACH LAYER OF FILL SHALL BE COMPACTED TO AT LEAST 95 PERCENT OF MAXIMUM DRY DENSITY DETERMINED BY THE ASTM D1557. COMPACTION OF STRUCTURAL FILL SHALL CONSIST OF FULLY LOADED TEN WHEEL TRUCKS, A TRACTOR DOZER WEIGHING AT LEAST 30,000 LBS AND OPERATED AT FULL SPEED, A HEAVY VIBRATORY ROLLER, OR OTHER METHOD ONLY AS APPROVED BY THE ENGINEER. COMPACTION OF SELECT COMMON FILL IN CONFINED AREAS ADJACENT TO STRUCTURES SHALL BE ACCOMPLISHED BY HAND OPERATED VIBRATORY EQUIPMENT OR MECHANICAL TAMPERS APPROVED BY THE ENGINEER. AS A MINIMUM, COMPACTION OF SELECT COMMON FILL SHALL CONSIST OF FOUR COVERAGES OF THE APPROVED EQUIPMENT.
- 6. SITE PREPARATION SHALL INCLUDE CLEARING, GRUBBING, DELETERIOUS SOILS, VEGETATION AND DEBRIS. ALL TREES, STUMPS, BRUSH, SHRUBS, ROOTS, GRASS, WEEDS, RUBBISH, STONES LARGER THAN 2-IN. IN THE LARGEST DIAMETER AND OTHER OBJECTIONABLE MATERIAL SHALL BE REMOVED AND DISPOSED OF FROM AREAS TO BE FILLED AND COMPACTED. AREAS OUTSIDE OF THE LIMITS OF WORK SHALL BE PROTECTED FROM DAMAGE AND NO EQUIPMENT OR MATERIALS SHALL BE STORED IN THESE AREAS. NO STUMPS, TREES, LIMBS, OR BRUSH SHALL BE BURIED IN ANY FILLS OR EMBANKMENTS.
- 7. EROSION AND SEDIMENT CONTROL, BOTH DURING AND AFTER CONSTRUCTION, SHALL BE PROVIDED AS REQUIRED TO RETAIN SEDIMENT ONSITE, AND TO CONTROL EROSION OF EMBANKMENTS, TEMPORARY AND FINAL EXPOSED SLOPES, AND TEMPORARY MATERIAL STOCKPILE(S). SILT FENCES, CHECK DAMS, DRAINAGE DITCHES OR SWALES, TEMPORARY SEEDING, AND PRE-MANUFACTURED TEXTILES, GEOTUBES, GEOGRID, CELLULAR GEOWEB, ETC., SHALL BE UTILIZED AS APPROPRIATE. EROSION AND SETTLEMENT CONTROL MEASURES SHALL BE IN ACCORDANCE WITH ALL PERMITS AND CODES AND THIS SPECIFICATION. DURING THE EXCAVATION OF THE WORK AT THE SITE, OPERATIONS SHALL BE CONTINUOUSLY MONITORED TO AVOID THE CREATION OF CONDITIONS THAT COULD LEAD TO EXCESSIVE EROSION OF SOIL WITH SURFACE RUNOFF FROM THE WORK AREAS. CONTROLS SHALL BE PROVIDED TO PROTECT THE WATER QUALITY AND SHALL BE IN ACCORDANCE WITH PROJECT DOCUMENTS AND ALL LOCAL, STATE AND FEDERAL LAWS AND REGULATIONS. EROSION CONTROL MEASURES SHALL BE EMPLOYED TO REDUCE EROSION OF SLOPES AND SILTATION OF OFF-SITE OUTFALLS AND TRIBUTARIES.
- 8. UPON SIGNS OF CONCENTRATED FLOW BY EVIDENCE OF GULLYING OR RILLING IN DISTURBED AREAS, STRAWBALES AND/OR STONE CHECK DAMS SHALL BE PLACED IN THESE AREAS, SPACED EVERY 50' IN THE UPGRADIENT SLOPE.
- 9. ALL DISTURBED AREAS SHALL BE RE-ESTABLISHED WITH "NEW ENGLAND CONSERVATION/WILDLIFE MIX" OR APPROVED EQUAL.

ESTABLISHED GUIDELINES FOR NEW <u>ENGLAND CONSERVATION/WILDLIFE MIX</u>

NEW ENGLAND WETLAND PLANTS, INC.

GENERAL:

THE MIX PROVIDES A PERMANENT COVER OF GRASSES, WILDFLOWERS AND LEGUMES TO PROVIDE BOTH GOOD EROSION CONTROL AND WILDLIFE HABITAT VALUE. THIS MIX IS DESIGNED TO BE A NO MAINTENANCE SEEDING, AND IT IS APPROPRIATE TO CUT AND FILL SLOPES, DETENTION BASIN SLOPES, AND DISTURBED AREAS ADJACENT TO COMMERCIAL AND RESIDENTIAL PROJECTS. ALWAYS APPLY ON CLEAN BARE SOIL. THE MIX MAY BE APPLIED BY HYDRO-SEEDING, BY MECHANICAL SPREADER, OR ON SMALL SITES IT CAN BE SPREAD BY HAND. LIGHTLY RAKE, OR ROLL TO ENSURE PROPER SEED TO SOIL CONTACT. BEST RESULTS ARE OBTAINED WITH A SPRING SEEDING. LATE SPRING THROUGH EARLY SUMMER SEEDING WILL BENEFIT WITH A LIGHT MULCHING OF WEED-FREE STRAW TO CONSERVE MOISTURE. IF CONDITIONS ARE DRIER THAN USUAL, WATERING WILL BE REQUIRED. LATE FALL AND WINTER DORMANT SEEDING REQUIRE AN INCREASE IN THE SEEDING RATE. FERTILIZATION IS NOT REQUIRED UNLESS THE SOILS ARE PARTICULARLY INFERTILE. PREPARATION OF A CLEAN WEED FREE SOIL SURFACE IS NECESSARY FOR OPTIMAL RESULTS.

- ELYMUS VIRGINICUS • SCHIZACHYRIUM SCOPARIUM
- FESTUCA RUBRA ANDROPOGON GERARDI.
- CHAMAECRISTA FASCICULATA PANICUM CLANDESTINUM PANICUM VIRGATUM
- SORGHASTRUM NUTANS HELENIUM AUTUMNALE
- HELIOPSIS HELIANTHOIDES
- VERBENA HASTATA ASCLEPIAS SYRIACA
- ASTER UMBELLATUS • EUPATORIUM PURPUREUM
- SOLIDAGO JUNCEA ZIZIA AUREA
- SEED BED PREPARATION:

REMOVE ALL INVASIVE SPECIES, TILL EXISTING SOIL AND RAKE SMOOTH. APPLY 3" OF COMPOSTED LEAF LITTER. ALL AREAS WHERE ROOTS HAVE BEEN GRUBBED SHALL BE

SEED APPLICATION AND RATE:

THE IDEAL PLANTING DEPTH IS 1/4-1/2". UNDER IDEAL CONDITIONS SEEDS LAYING ON THE SURFACE WILL GERMINATE. RECOMMENDED APPLICATION RATE FOR SEEDING IS 1 LBS PER 1,750 SQUARE FEET.


FOR FALL INSTALLATION, SEED BETWEEN AUGUST 15 AND SEPTEMBER 10. FOR SPRING INSTALLATION, SEED AS EARLY AS POSSIBLE SOMETIME BETWEEN APRIL 15 AND MAY 10.


FERTILIZATION AND SOIL REQUIREMENTS: REFER TO MANUFACTURERS RECOMMENDATIONS

GENERAL MAINTENANCE:

REFER TO MANUFACTURERS RECOMMENDATIONS

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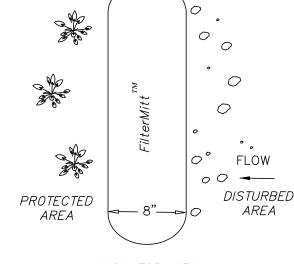


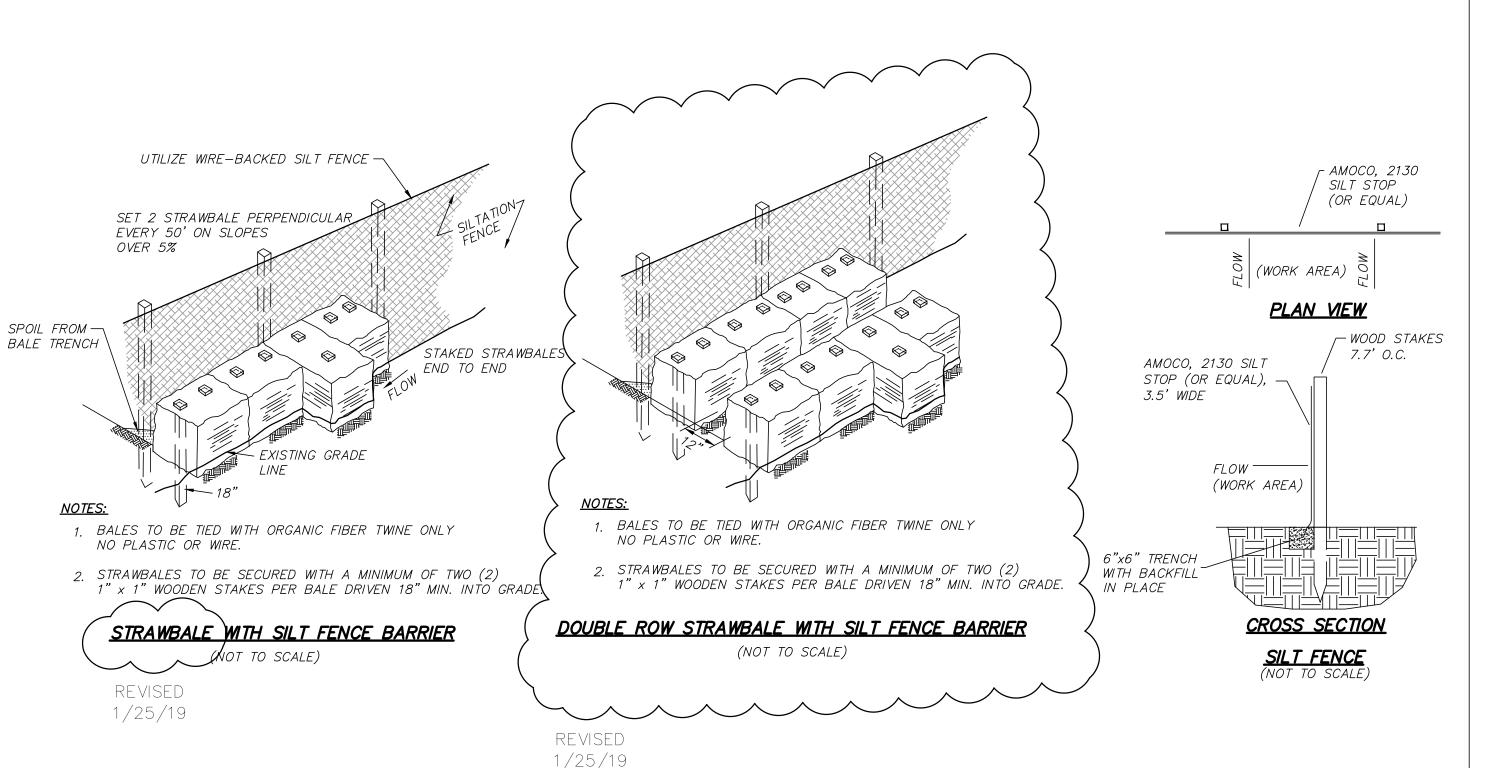

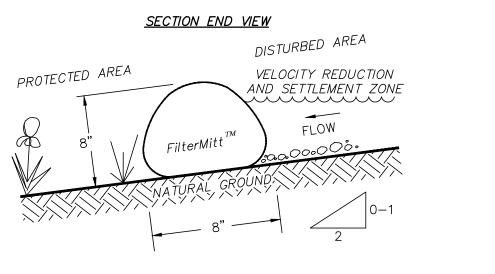
DISTURBED AREA

FLOW

AND SETTLEMENT ZONE



SECTION TOP VIEW

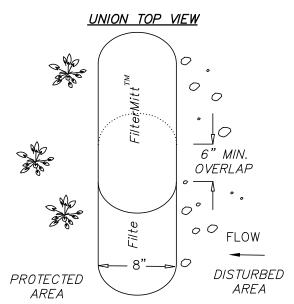

FilterMitt[™] COMPONENTS:

PROTECTED AREA

OUTSIDE CASING: 100% organic hessian.

UNION END VIEW

- FiberRoot Mulch TM FILLER INGREDIENT:
- A BLEND OF COARSE AND FINE COMPOST AND SHREDDED • PARTICLE SIZES: 100% PASSING A 3" SCREEN; 90-100%
- PASSING A 1" SCREEN; 70-100% PASSING A 0.75" SCREEN; 30-75% PASSING A 0.25" SCREEN.
- WEIGHT: APPROX. 310 LBS./CU.YD. (AVE. 11.5 LBS./L.F.)

For more information visit: <u>www.groundscapesexpress.com</u>or contact us at: Groundscapes Express, Inc.

P.O. Box 737 Wrentham, MA 02093 **FILTERMITT** (508) 384-7140

(NOT TO SCALE)


FilterMitt[™] **INSTALLATION:**

WITH THE NEWEST TECHNOLOGY AND EQUIPMENT, SECTIONS CAN BE CONSTRUCTED ON SITE IN LENGTHS FROM 1' TO 100'.


SECTIONS CAN ALSO BE DELIVERED TO THE SITE IN LENGTHS FROM 1' TO 8'.

THE FLEXIBILITY OF FilterMitt TM ALLOWS IT TO CONFORM TO ANY CONTOUR OR TERRAIN WHILE HOLDING A SLIGHTLY ROUND SHAPE AT 8" HIGH BY 8" WIDE.


WHERE SECTION ENDS MEET, THERE SHALL BE AN OVERLAP OF 6" OR GREATER.

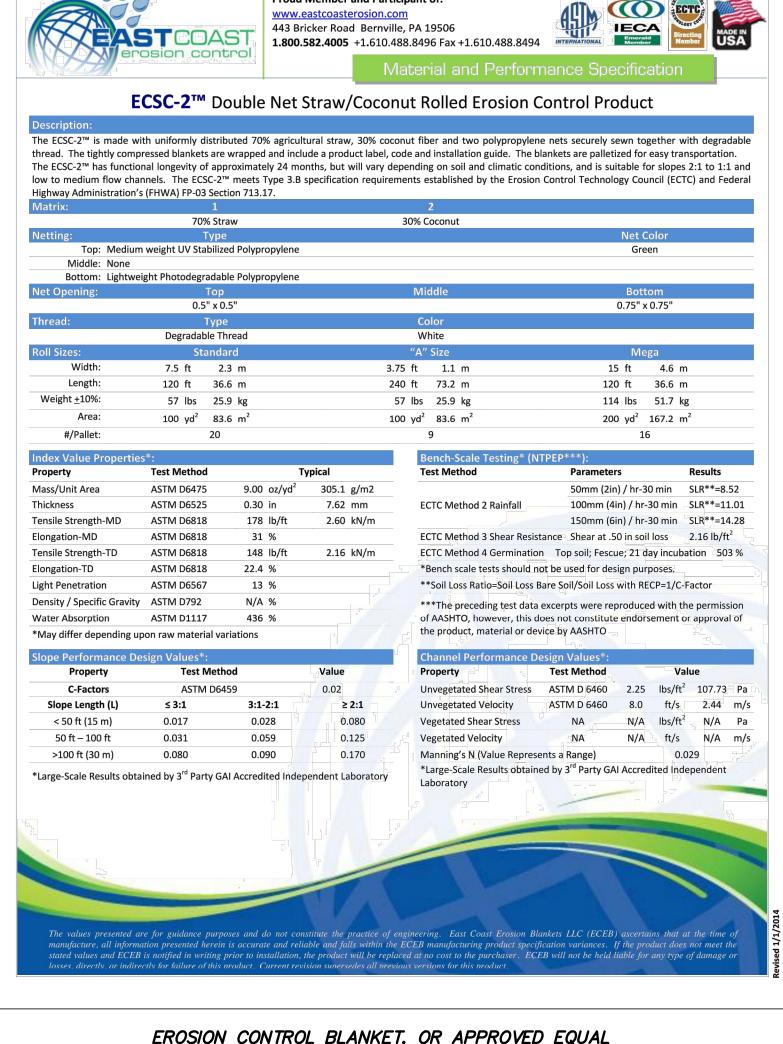

EROSION CONTROL BLANKET. OR APPROVED EQUAL

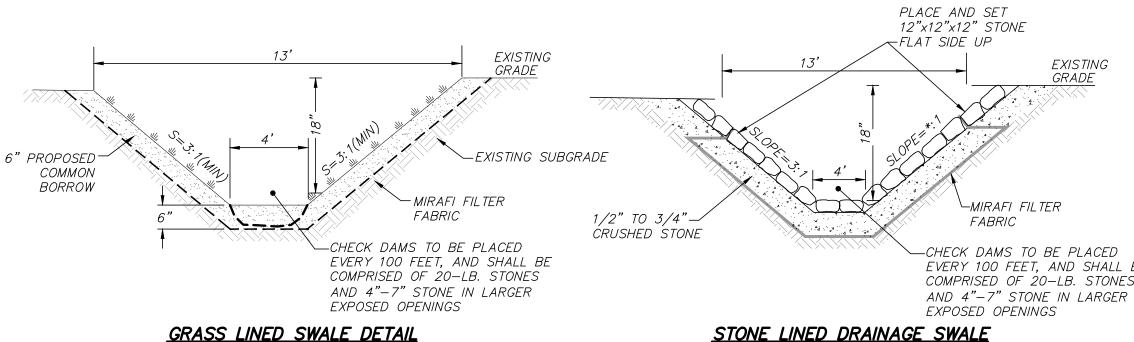

(NOT TO SCALE)

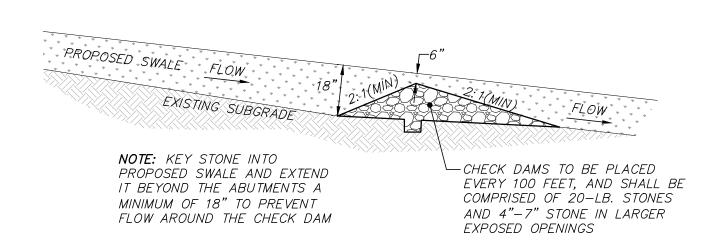


TYPICAL STONE CHECK DAM

(NOT TO SCALE)

BK. #672, PG. #69 DWG. NO. 6091_SITE(WEST)-1.DWG

FOR PERMITTING ONLY NOT FOR CONSTRUCTION

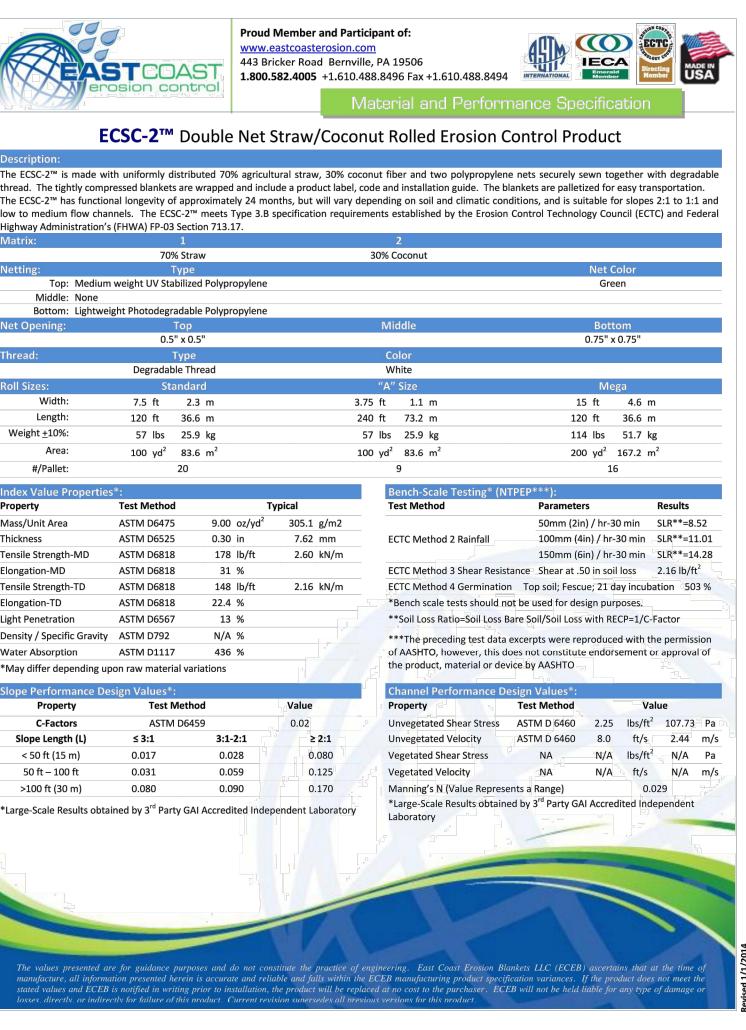

95 EROSION

EVERY 100 FEET, AND SHALL BE COMPRISED OF 20-LB. STONES AND 4"-7" STONE IN LARGER

STONE LINED DRAINAGE SWALE

(NOT TO SCALE)





NOTES



IANUARY 1, 2019 SCALE:

NOT TO SCALE 12 of 13

PROJECT No.

